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#### 1/3/22

#### **Driscoll School Project**

### Change Order #7 Summary

Change Proposal Number	Change Value
ATP#0021 / OS 00036 ASI 14 - Metal Panel Color	\$ 0.00
ATP#0022 / OS 00042 RFI 139 - Wide Style Door	\$ 10,893.00
ATP#0023 / OS 00040 RFI 160 - Sanitary Sewer	\$ -4,052.00
ATP#0025 / OS 00027 ASI 008 - Gridline SC1	\$ 0.00
ATP#0026 / OS 00024 RFI 46 - HVAC Piping	\$ 0.00
Total Change Order Value	\$6,841.00

#### ATP#0021 / OS 00036 ASI 14 - Metal Panel Color

\$ 0.00

No cost change to make formal selection of standard color by selected manufacturer per specifications

#### ATP#0022 / OS 00042 RFI 139 - Wide Style Door

\$ 10,893.00

Exterior storefront doors changed from medium width to wide width for added durability and to coordinate with selected hardware manufacturer's requirements.

#### ATP#0023 / OS 00040 RFI 160 - Sanitary Sewer

\$ -4,052.00

Credit per discussion with Brookline DPW, pipe to pipe connection in lieu of doghouse connection in Washington Street.

#### ATP#0025 / OS 00027 ASI 008 - Gridline SC1

\$ 0.00

No cost coordination change to make gridline adjustments by fraction of an inch

#### ATP#0026 / OS 00024 RFI 46 - HVAC Piping

\$ 0.00

No cost coordination change to make HVAC pipe size adjustments

#### Owner Change Order (OCO)

Project Name: Brookline - Driscoll

School

Gilbane Job No.: J08864.000



OCO: OCO-0007

PCI:OS-00024, OS-00027, OS-00036, OS-00040, OS-00042 Alternate Tracking #:

Attention: Date Issued: 1/4/2022 12:17:48 PM

Owner: Town of Brookline

Address: 333 Washington Street

Brookline, MA 02445 US

Architect: Jonathan Levi Architects LLC, Mark Warner

The Contract changes as follows: Scope Of Changes: Misc Changes

Description: ATP 0021/ OS 00036 Metal Panel Color ATP 0022/OS 0042 Wide Style Door revisions ATP 0023/ OS -00040 RFI 160 ATP 0025/ OS 00027 ASI 008 ATP 0026/OS 00024 RFI 146

Additional Description

#### Attachments:

Number	Title	PCI	Change Date	Revision
00205764	ATP-25 Backup	OS-00027	12/14/2021	Original Version
00205913	REV 1-ATP-21 Backup	OS-00036	12/17/2021	Original Version
00205382	ATP-23 Backup	OS-00040	12/07/2021	Original Version
00206143	REV 1-ATP-22 Backup Pricing	OS-00042	12/22/2021	Original Version

PCI Code	PCI Description	Amount	Accept
II .	RFI #46 HVAC Pipe Size Clarification	\$.00	C Yes C No
OS-00027	ASI #8 Gridlines SC1 and AU.1	\$.00	C Yes C No
OS-00036	REV 1-ASI #14 Exterior Metal Colors	\$.00	C Yes C No
	RFI #160 Washington Street Sanitary Sewer Connection	-\$4,052.00	C Yes C No
II .	RFI #139 Wide Syle Door Leaf- Exterior Openings	\$10,893.00	C Yes C No

Submitted Amt: \$6,841.00 T

Total:

\$6,841.00

PROJECT NUMBER: J08864.000 OCO: OCO-0007 Page: 2 of 4

Signature of the Owner indicates agreement herewith, including any adjustment in the Contract Sum or the Contract Time

The Original Contract price was \$94,298,030.00

Net change by previously authorized Change Orders \$4,748,646.00

Contract Price prior to this Change Order \$99,046,676.00

Contract Price will be changed by this Change Order in the Amount \$6,841.00

The new Contract Price including this Change Order will be \$99,053,517.00

The Contract Time will be changed by

The date of Substantial Completion for construction as of the date of  $\,$  07/11/2024

this Change Order therefore is

Gilbane Building Company

#### Gilbane Building Company

Signed: 1/4/2022 12:17:48 PM Eastern Standard Time - By: Walter J. Kincaid (Senior Project Executive )

Gilbane Building Company: 10.41.123.84

Jonathan Levi Architects LLC

Ву:	
Title:	
Company:_	
Date:	
Printed Name:	

LEFTFIELD, LLC

Ву:	
Title:	
Company:_	
Date:	
Printed Name:	

Town of Brookline

Ву:	
Title:	
Company:	
Date:	
Printed Name:	

0

PROJECT NUMBER: J08864.000 OCO: OCO-0007 Page: 3 of 4

PROJECT NUMBER: J08864.000 OCO: OCO-0007	Page: 4 of 4

#### Gilbane Building Company **Authorization To Proceed**



CONTRACT FOR: Brookline - Driscoll School

OWNER: Town of Brookline 333 Washington Street ADDRESS:

Brookline, MA, 02445

PROJECT NUMBER: ATP NO:

ATP-0021 ATP VERSION: REV 1

DATE OF ISSUANCE: SUBMITTED BY:

12/17/2021 Gilbane Building

J08864.000

Company

**ALTERNATE** TRACKING #:

ARCHITECT: Jonathan Levi Architects LLC, Mark Warner

The Contract Documents are hereby amended to include the additional Work described below, which is outside of the current scope of the Work and constitutes a change.

Upon Owner approval, Gilbane Building Company will proceed with the Work promptly.

Costs as incurred are in addition to the current contract Sum and will be invoiced and paid on a monthly basis and identified as separate items within the requisition. Once final cost of the Work involved and change in Sum and Time (if any) are fully determined, it will be submitted for inclusion in a final Change Order adjusting the Contract Sum and/or Time.

TITLE: REV 1-ASI 14 Color of Metal Panel

DESCRIPTION: This ATP represents cost to add REV 1 ASI #14 Exterior Metal Color dated 12/15/2021 has been incorporated into the contract at No Cost.

#### Attachments:

Number	Description:	PCI Number	Change Date	Revision
00205913	REV 1-ATP-21 Backup	OS-00036	12/17/2021	Original Version

The Following information is provided by Gilbane Building Company

Method of determining change in Contract:

☑ Guaranteed Maximum Price	Cost Plus Fee	Unit Price	Lump Sum
□ Other			

Change In Contract Sum Dollar Amount: \$.00

■ Estimated ■ Time and Material Fixed ■ Maximum

> Change In Contract Time Time (Days): TBD

Fixed □ Estimated

Job	PCI No.	Description	Phase Code	SubContractor	Amount	Accept?
J08864.000	OS-00036	Metal Panels	01.07C.074000.X	Salem Glass Company	\$.00	C Yes C No

Job	PCI No.	Description	Phase Code	SubContractor	Amount	Accept?
J08864.000	OS-00036	Gen & Excess Liability Insurance	99.970.950050.Z		\$.00	C Yes C No
J08864.000	OS-00036	Performance & Payment Bond	99.970.997000.Z		\$.00	C Yes C No
J08864.000	OS-00036	Subcontractor Default Insurance	99.975.996000.Z		\$.00	C Yes C No
J08864.000	OS-00036	Fee	99.999.999000.Z		\$.00	C Yes C No
TOTAL FOR PCI No.	OS-00036				\$0.00	

Submitted Amt: \$.00

	Sill	ane	Buildina	Company	V
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#### Gilbane Building Company

Signed: 12/20/2021 12:33:13 PM Eastern Standard Time - By: Lynda Callahan (Senior Project Manager )

Gilbane Building Company: 10.20.1.150

onathan Levi Architects LLC

By: MesaRy Server

Title: Principal

Company: Jonathan Levi Architects

Date: 12/20/21

Printed Name: Mark L Warner

.EFTFIELD, LLC

By: Lynn Stapleton

Title: OPM

Company: LeftField Project Management

Date: 12/21/21

Printed Name: Lynn Stapleton

own of Brookline

REVIEWED

By:

Title:

Company: T. O. B.

Date: 23 DECEMBER 2021

Printed Name: ANTHONY GUIGEI

#### Request for Quotation (RFQ)

Project Name: Brookline - Driscoll

School

Gilbane Project No.: J08864.000



PCI: OS-00036

Due Date: 12/23/2021

Attention: Jeff Ray

To: Salem Glass Company

3 Technology Way

Salem MA 01970

Contract: J08864.000-0018

Date Issued: 12/16/2021 7:40:39 AM

PCI Subject: REV 1-ASI #14 Exterior Metal Colors

Scope: Per REV 1- ASI #14 revise the exterior metal paint colors for storefront, cap covers, composite panels, and extruded trim.

Please provide Pricing for REV 1- ASI #14 Exterior Metal Colors dated 12/15/21.

Attachments:

Number Title **Change Date** Revision 00204864 ASI-014 Exterior Metal Colors & 11/22/2021

**CHANNEL Sketch Option** 

Original Version

□ Submittal(s) required

Proceed with the work & submit quotation

Return this request with your quotation noted below and attach all detailed documentation for the change outlined above. Your quotation will not be considered valid unless detailed documentation is included. Failure to comply will result in payment delays.

#### Section to be Completed by the Trade Contractor

No Change to contract price or schedule

The following pricing is for the changes outlined above. Zero (\$0) dollars have been entered for changes that have no cost impact.

Job	Phase Code	Description	Quoted Amount	<b>Diversity Participation</b>
J08864.000	01.07C.074000.X	Metal Panels	\$ \$0.00	

This change increases/(decreases) our Disadvantaged Business Enterprise participation by the below amounts which are included in the above quotation:

Phase Code	Company	(Minority) MBE	(Women) WBE	(Small) SBE	Other	Disadvantaged DBE
01.07C.074000.X	Salem Glass Company	%	%	%	%	%

days
Note that any days extension requested will require substantiating documentation to support the request for time including demonstration of the direct impact to the critical path. If left blank, no additional time extensions will be accepted.
Upload Your Supporting Documentation Here

The above changes will necessitate additional days extension of the original contract completion date by

#### **Signatures**

Gilbane Building Company

#### Gilbane Building Company

Signed: 12/16/2021 7:40:39 AM Eastern Standard Time - By: Colleen Shouldice, (Senior Project Engineer )

Gilbane Building Company: 10.20.1.124

Salem Glass Company

By: Project Manager Title: Company: Salem Glass Co. 12/16/21 Date: Printed Name: Jeff R Ray



To: Lynda Callahan

Project Name: Driscoll School Date of Issuance: December 15, 2021

Project No.: 1823 ASI No.: 014R

Re: Exterior Metal Colors


The work shall be carried out in accordance with the supplemental instructions described herein issued in accordance with the Contract Documents without change in the Contract Sum or Contract Time. Prior to proceeding in accordance with these instructions, indicate your acceptance of these instructions for minor change to the Work as consistent with the Contract Documents and return a copy to the Designer. The additions, deletions, or modifications described herewith are for information only. Changes to the contract will be accomplished by Change Order or Construction Change Directive.

#### **DESCRIPTION**

Revised exterior metal paint colors for storefront, cap covers, composite panels and extruded trim.

**ATTACHMENTS** 

A SK 040.1 - EXTERIOR METAL PAINT COLOR

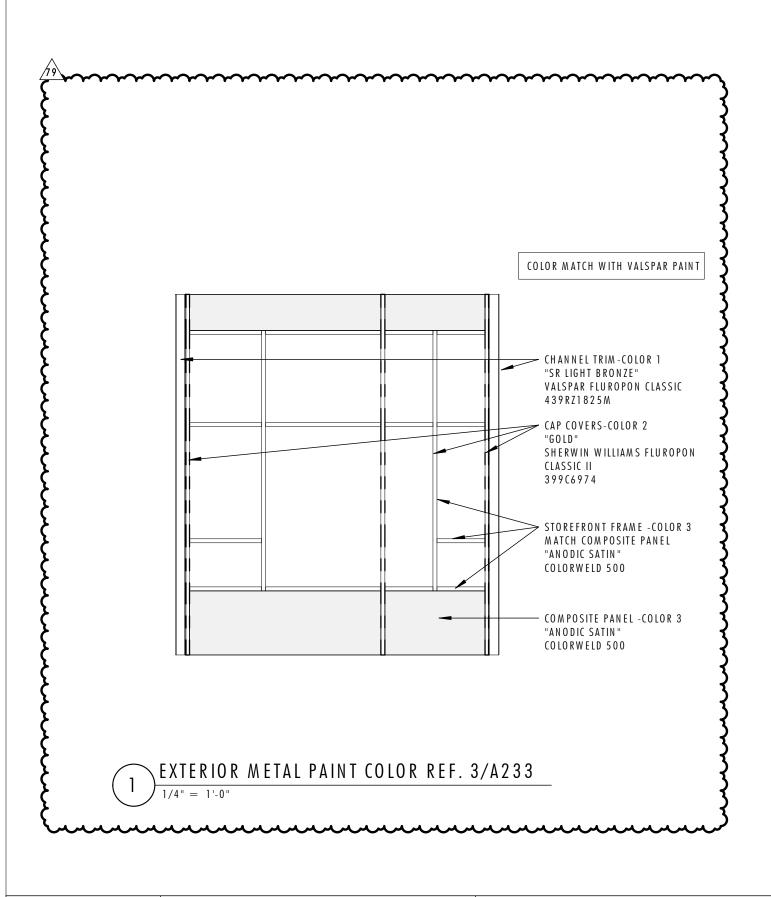

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TOWN OF BROOKLINE
DRISCOLL SCHOOL

sketch Title

ASI 014R - EXT METAL PAINT COLOR

Issued V	/ith:		
No:	Date:	Descri	ption:
79	12/14/21	ASI-014	4.1
Reference	ce Sheet:		Sketch Number

Project No.: 1823 Scale: 1/4" = 1'-0"

A SK 040.1



To: Lynda Callahan

Project Name: Driscoll School Date of Issuance: December 15, 2021

Project No.: 1823 ASI No.: 014R

Re: Exterior Metal Colors


The work shall be carried out in accordance with the supplemental instructions described herein issued in accordance with the Contract Documents without change in the Contract Sum or Contract Time. Prior to proceeding in accordance with these instructions, indicate your acceptance of these instructions for minor change to the Work as consistent with the Contract Documents and return a copy to the Designer. The additions, deletions, or modifications described herewith are for information only. Changes to the contract will be accomplished by Change Order or Construction Change Directive.

#### **DESCRIPTION**

Revised exterior metal paint colors for storefront, cap covers, composite panels and extruded trim.

**ATTACHMENTS** 

A SK 040.1 - EXTERIOR METAL PAINT COLOR

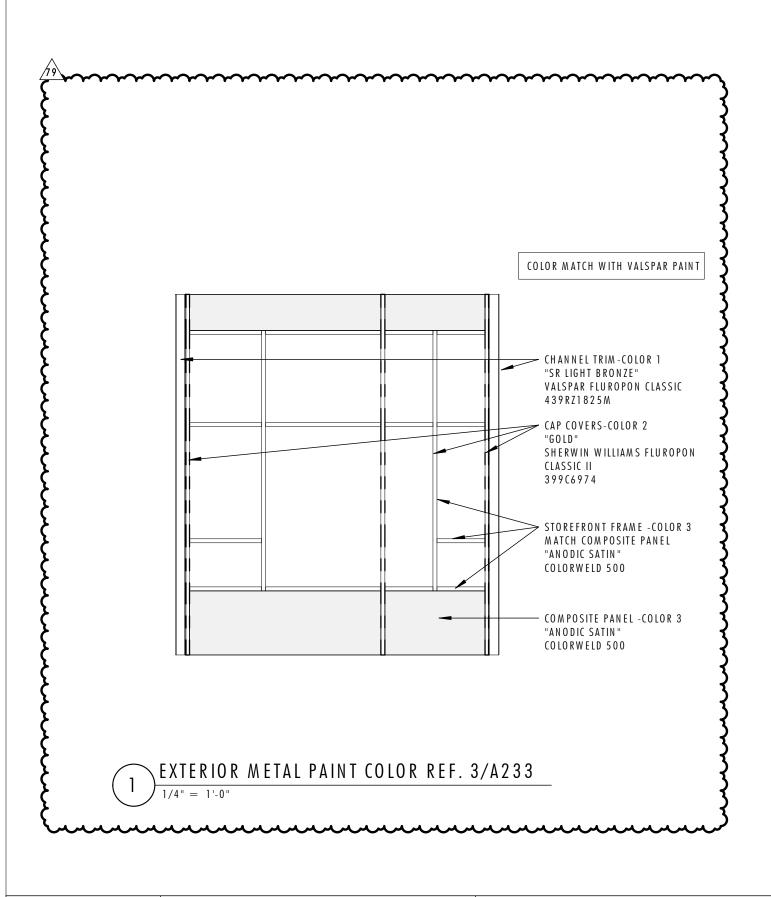

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TOWN OF BROOKLINE
DRISCOLL SCHOOL

sketch Title

ASI 014R - EXT METAL PAINT COLOR

Issued V	/ith:		
No:	Date:	Descri	ption:
79	12/14/21	ASI-014	4.1
Reference	ce Sheet:		Sketch Number

Project No.: 1823 Scale: 1/4" = 1'-0"

A SK 040.1

#### Gilbane Building Company **Authorization To Proceed**

ARCHITECT:



CONTRACT FOR: Brookline - Driscoll School

OWNER: Town of Brookline 333 Washington Street ADDRESS:

Brookline, MA, 02445

Jonathan Levi Architects LLC, Mark Warner

PROJECT NUMBER: ATP NO: ATP VERSION: DATE OF ISSUANCE: SUBMITTED BY:

12/20/2021 Gilbane Building Company

J08864.000

ATP-0026

**ALTERNATE** TRACKING #:

The Contract Documents are hereby amended to include the additional Work described below, which is outside of the current scope of the Work and constitutes a change.

Upon Owner approval, Gilbane Building Company will proceed with the Work promptly.

Costs as incurred are in addition to the current contract Sum and will be invoiced and paid on a monthly basis and identified as separate items within the requisition. Once final cost of the Work involved and change in Sum and Time (if any) are fully determined, it will be submitted for inclusion in a final Change Order adjusting the Contract Sum and/or Time.

TITLE: RFI #46 HVAC Piping

**DESCRIPTION:** This ATP represents NO Cost to add RFI#46 to the contract documents.

#### Attachments:

Fixed

Number	Description:	PCI Number	Change Date	Revision							
The Following information is provided by Gilbane Building Company  Method of determining change in Contract:											
✓ Guaranteed Maximum Price ✓ Other	9	Cost Plus Fee	<b>□</b> Unit Price	☐ Lump Sum							
		Change In Contract Sum Dollar Amount: \$.00									

Change In Contract Time Time (Days): TBD

Fixed 

■ Estimated

Job	PCI No.	Description	Phase Code	SubContractor	Amount	Accept?
J08864.000	OS-00024	HVAC	01.23A.230000.TC	Patrick J Kennedy & Sons Inc	\$.00	C Yes C No
J08864.000	OS-00024	Gen & Excess Liability Insurance	99.970.950050.Z		\$.00	C Yes C No

■ Time and Material

Job	PCI No.	Description	Phase Code	SubContractor	Amount	Accept?
J08864.000	OS-00024	Performance & Payment Bond	99.970.997000.Z		\$.00	C Yes C No
J08864.000		Subcontractor Default Insurance	99.975.996000.Z		\$.00	C Yes C No
TOTAL FOR PCI No.	OS-00024		\$0.00			

Submitted Amt: \$.00

Silbane	Building	Company
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#### Gilbane Building Company

Signed: 12/20/2021 8:20:53 AM Eastern Standard Time - By: Lynda Callahan (Senior Project Manager )

Gilbane Building Company: 10.20.1.61

onathan Levi Architects LLC

ande.

.EFTFIELD, LLC

By:	Lynn Stapleton
Title:	OPM
Company:	LeftField Project Management
Date:	12/21/21
Printed Name:	Lynn Stapleton

own of Brookline

REYIEWED

ву:		
Title: _		
Company:	T.O.B.	1
Date:	23 DECE	MBER 2021
Printed Name:	ANTHONY	GUIGLI

## Callahan, Lynda M.

From: Ullman, Derek R.

Sent: Wednesday, October 27, 2021 10:30 AM

**To:** Callahan, Lynda M.

**Subject:** FW: Michael Driscoll Pricing open Changes

**Importance:** High

### RFI 46 confirmed no change.

#### **Derek Ullman**

Project Manager | ENR 2021 Top Young Professionals

Gilbane Building Company | Celebrating 150 Years

10 Channel Center St, STE 100 Boston MA, 02120

O 617-478-3334 | M 857-208-0274

www.gilbaneco.com

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From: Callahan, Lynda M. <LCallahan@Gilbaneco.com>

**Sent:** Tuesday, October 26, 2021 10:11 AM

To: Ray Hanley <rhanley@pjkennedy.com>; Patrick Kennedy <patrick@pjkennedy.com>

**Cc:** Ullman, Derek R. <DUllman@GilbaneCo.com> **Subject:** Michael Driscoll Pricing open Changes

Importance: High

Hello Ray/Pat

Can you please provide update on the following PCI's

ASI #1 HVAC OS-00015 issued on 9/1/21 RFI 46 HVAC Pipe Sizing OS -00024 issued on 10/15/21

I need to move forward on these items if you could provide response I would appreciate it. Thank you.

Lynda Callahan | Sr. Project Manager | Gilbane Building Company

10 Channel Center St | Boston, MA | 02210

O: (617)960-2956 | M: (617)320-5153 | F: (617)478-3001

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Gilbane, a three-time member of Fortune's "100 Best Places to Work" list and a thirteen-time member of *Training Magazine's* Top 125



Gilbane Building Company 10 Channel Center Street Suite 100

Boston, Massachusetts 02210 Phone: (617) 478-2981

Project: J08864.000 - Michael Driscoll School - Brookline 64 Westbourne Terrace Brookline, Massachusetts 02446

# **HVAC Pipe Size Clarifications - Riser Diagram vs Plans**

TO: Sean Strassell (Garcia Galuska DeSousa Inc)

CA GGD (Garcia Galuska DeSousa Inc) Mark Warner (Jonathan Levi Architects LLC) Carol Harris (Jonathan Levi Architects LLC)

(Response Required)

**DATE INITIATED:** 09/01/2021

LOCATION:

**PROJECT STAGE:** Coordination

SUB JOB:

COST IMPACT: **TBD** 

DRAWING NUMBER: M021, M030, M200A, M202B, M203B, M204A,

M204B

LINKED DRAWINGS: M021, M030, M200A, M202B, M203B, M204A,

M204B

RECEIVED FROM: Ray Hanley (Patrick J. Kennedy & Sons, Inc.)

COPIES TO:

Brady Whitehill (Gilbane Building Company)

FROM: Ray Hanley (Patrick J. Kennedy & Sons,

STATUS: Closed on 09/21/21

**DUE DATE:** 09/06/2021

COST CODE:

SCHEDULE IMPACT: TBD

SPEC SECTION: 23 00 01 - HVAC

REFERENCE:

#### Question from Ray Hanley (Patrick J. Kennedy & Sons, Inc.) at 01:24 PM on 08/24/2021

Dwg M021 HVAC Airflow and Hydronic Riser Diagram currently notes pipe sizes differing from the floor plans . Please review and confirm the following sizes as shown on the floor plans are correct:

RTU-4

CHWS/R is 5in per M204B

HHWS/R is 4in per M204B

RTU-5

CHWS/R is 4in per M204A

HHWS/R is 3in per M204A

AHU-1 & 2

HHWS/R Branch is 3in per M200A

AHU-1

CHWS/R is 2.5in per M200A, M030 HHWS/R is 2in per M200A, M030

CHWS/R is 2in per M200A, M030

HHWS/R is 1.5in per M200A, M030

MAU-1

CHWS/R is 2.5in per M200A

HHWS/R is 2in per M200A

HHWS/R Riser at SA6 (M202B Markup)

Confirm Level 2 tagging should read HHWS/R 6in Up & 8in Down per M203B & M021

Markup of the locations are shown on the attached.

Attachments:

BDS HVAC PJK RFI 003 - HVAC Piping Size Clarifications.pdf

Awaiting an Official Response

## All Replies:





Response from Carol Harri	s (Jonathan Levi Architec	ts LLC) at 04:39 PM on	09/17/2021	
Refer to GGD response attached.				
Attachments:				
RFI #046 GGD RESPONSE.pdf				
If the information provided in the respunces authorized to do so by the Co	nstruction Manager in writing. The	trade contractor shall provide t	the Construction Manager written	notice within five
(5) working days from receipt of th Agreement. Should no change be rec	is Request for Information that t	his RFI constitutes a change,	all in accordance with Article 8	3 of the Contract
ВҮ	DATE		COPIES TO	



#### **REQUEST FOR INFORMATION - RFI**

M#77709 J#680 018 00.00

DATE: September 17, 2021

TO: Carol Harris

Jonathan Levi Architects

FROM: Sean Strassell

DEPT: HVAC

PROJECT: Driscoll School

Brookline, MA

SUBJECT: RFI #046 HVAC Pipe Size Clarifications

#### Question:

Dwg M021 HVAC Airflow and Hydronic Riser Diagram currently notes pipe sizes differing from the floor plans . Please review and confirm the following sizes as shown on the floor plans are correct:

RTU-4

CHWS/R is 5in per M204B

HHWS/R is 4in per M204B

RTU-5

CHWS/R is 4in per M204A

HHWS/R is 3in per M204A

AHU-1 & 2

HHWS/R Branch is 3in per M200A

AHU-1

CHWS/R is 2.5in per M200A, M030

HHWS/R is 2in per M200A, M030

AHU-2

CHWS/R is 2in per M200A, M030

HHWS/R is 1.5in per M200A, M030

MAU-1

CHWS/R is 2.5in per M200A

HHWS/R is 2in per M200A

HHWS/R Riser at SA6 (M202B Markup)

Confirm Level 2 tagging should read HHWS/R 6in Up & 8in Down per M203B & M021

Markup of the locations are shown on the attached.

#### Response:

All pipe sizing shall be as noted on floor plans with the following clarifications:

- 1. AHU-1 & 2 HHWS/R is indicated as 2.5" per M200A, CHWS/R is 3".
- 2. HHWS/R note on drawings M202B shall read as "6" up, & 8 "down", as suggested by P.J. Kennedy.

SS: cl Enc.

Cc: Mark L. Warner AIA LEED BD+C, Jonathan Levi Architects



Gilbane Building Company 10 Channel Center Street Suite 100 Boston, Massachusetts 02210

Phone: (617) 478-2981

SEPTEMBER 1, 2021 **GGD Consulting Engineers, Inc.** 

Inc.)

Open

09/06/2021

23 00 01 - HVAC

**RFI #046** 

Project: J08864.000 - Michael Driscoll School - Brookline 64 Westbourne Terrace Brookline, Massachusetts 02446

Ray Hanley (Patrick J. Kennedy & Sons,

# **HVAC Pipe Size Clarifications**

FROM:

STATUS:

**DUE DATE:** 

COST CODE:

SPEC SECTION:

REFERENCE:

**SCHEDULE IMPACT:** TBD

TO: Mark Warner (Jonathan Levi Architects LLC)

Carol Harris (Jonathan Levi Architects LLC)

(Response Required)

CA GGD (Garcia Galuska DeSousa Inc) Sean Strassell (Garcia Galuska DeSousa Inc)

**DATE INITIATED:** 09/01/2021

LOCATION:

**PROJECT STAGE:** Coordination

SUB JOB:

**COST IMPACT:** 

DRAWING NUMBER: M021, M030, M200A, M202B, M203B, M204A,

M204B

**LINKED DRAWINGS:** 

RECEIVED FROM: Ray Hanley (Patrick J. Kennedy & Sons, Inc.)

COPIES TO:

## Question from Ray Hanley (Patrick J. Kennedy & Sons, Inc.) at 01:24 PM on 08/24/2021

Dwg M021 HVAC Airflow and Hydronic Riser Diagram currently notes pipe sizes differing from the floor plans . Please review and confirm the following sizes as shown on the floor plans are correct:

RTU-4

CHWS/R is 5in per M204B

HHWS/R is 4in per M204B

RTU-5

CHWS/R is 4in per M204A

HHWS/R is 3in per M204A

AHU-1 & 2

HHWS/R Branch is 3in per M200A

CHWS/R is 2.5in per M200A, M030

HHWS/R is 2in per M200A, M030

AHU-2

CHWS/R is 2in per M200A, M030

HHWS/R is 1.5in per M200A, M030

MAU-1

CHWS/R is 2.5in per M200A

HHWS/R is 2in per M200A

HHWS/R Riser at SA6 (M202B Markup)

Confirm Level 2 tagging should read HHWS/R 6in Up & 8in Down per M203B & M021

Markup of the locations are shown on the attached.

#### Attachments:

BDS\_HVAC PJK RFI 003 - HVAC Piping Size Clarifications.pdf

Awaiting an Official Response

#### **All Replies:**





If the informat	ion provided in th	e response to the	nis RFI constitutes	a change in	contract price	or time, the t	rade contractor	shall not pro	oceed with	this work
unless authori	zed to do so by t	he Construction	Manager in writin	g. The trade	contractor shall	I provide the	Construction N	/lanager writt	en notice v	vithin five
(5) working d	ays from receipt	of this Reques	t for Information	that this RF	I constitutes a	change, all	in accordance	e with Article	e 8 of the	Contract
Agreement. S	hould no change	be required, a n	o cost change will	be issued to	you incorporati	ing this RFI ii	nto your contra	ct.		

ВҮ	DATE	COPIES TO



# Patrick J. Kennedy & Sons, Inc. MECHANICAL CONTRACTORS

Number: 3

REQUEST FOR INFORMATION

Date: 08/24/2021

Phone:

39 Gibson Street Boston, MA 02122-1222 Ph: (617)265-5535

Job: 2021-05 Driscoll School - HVAC

To:""Öolleen Shouldice

Gilbane Building Co Driscoll School

10 Channel Center St, Suite 10

Boston, MA 02120

CC:

Subject: HVAC Piping Size Clarifications

**Drawing:** M021, M030, M200A, M202B, M203B, **Spec Section:** 

M204A, M204B

Cost Impact: None Schedule Impact: None

Request: Date Required:

Dwg M021 HVAC Airflow and Hydronic Riser Diagram currently notes pipe sizes differing from the floor plans. Please review and confirm the following sizes as shown on the floor plans are correct:

RTU-4

CHWS/R is 5in per M204B HHWS/R is 4in per M204B

RTU-5

CHWS/R is 4in per M204A HHWS/R is 3in per M204A

AHU-1 & 2

HHWS/R Branch is 3in per M200A

AHU-1

CHWS/R is 2.5in per M200A, M030 HHWS/R is 2in per M200A, M030

AHU-2

CHWS/R is 2in per M200A, M030 HHWS/R is 1.5in per M200A, M030

MAU-1

CHWS/R is 2.5in per M200A HHWS/R is 2in per M200A

HHWS/R Riser at SA6 (M202B Markup)

Confirm Level 2 tagging should read HHWS/R 6in Up & 8in Down per M203B & M021

Requested by: Raymond Hanley

Patrick J. Kennedy & Sons, Inc



# Patrick J. Kennedy & Sons, Inc. MECHANICAL CONTRACTORS

Number: 3

Date: 08/24/2021

**REQUEST FOR INFORMATION** 

Phone:

39 Gibson Street Boston, MA 02122-1222 Ph: (617)265-5535


2021-05 Driscoll School - HVAC

To: colleen Shouldice Gilbane Building Co Driscoll School

10 Channel Center St, Suite 10

Boston, MA 02120

Answered by  Company  Date	Response:	
Company Date	Answered by	
	Company	Date

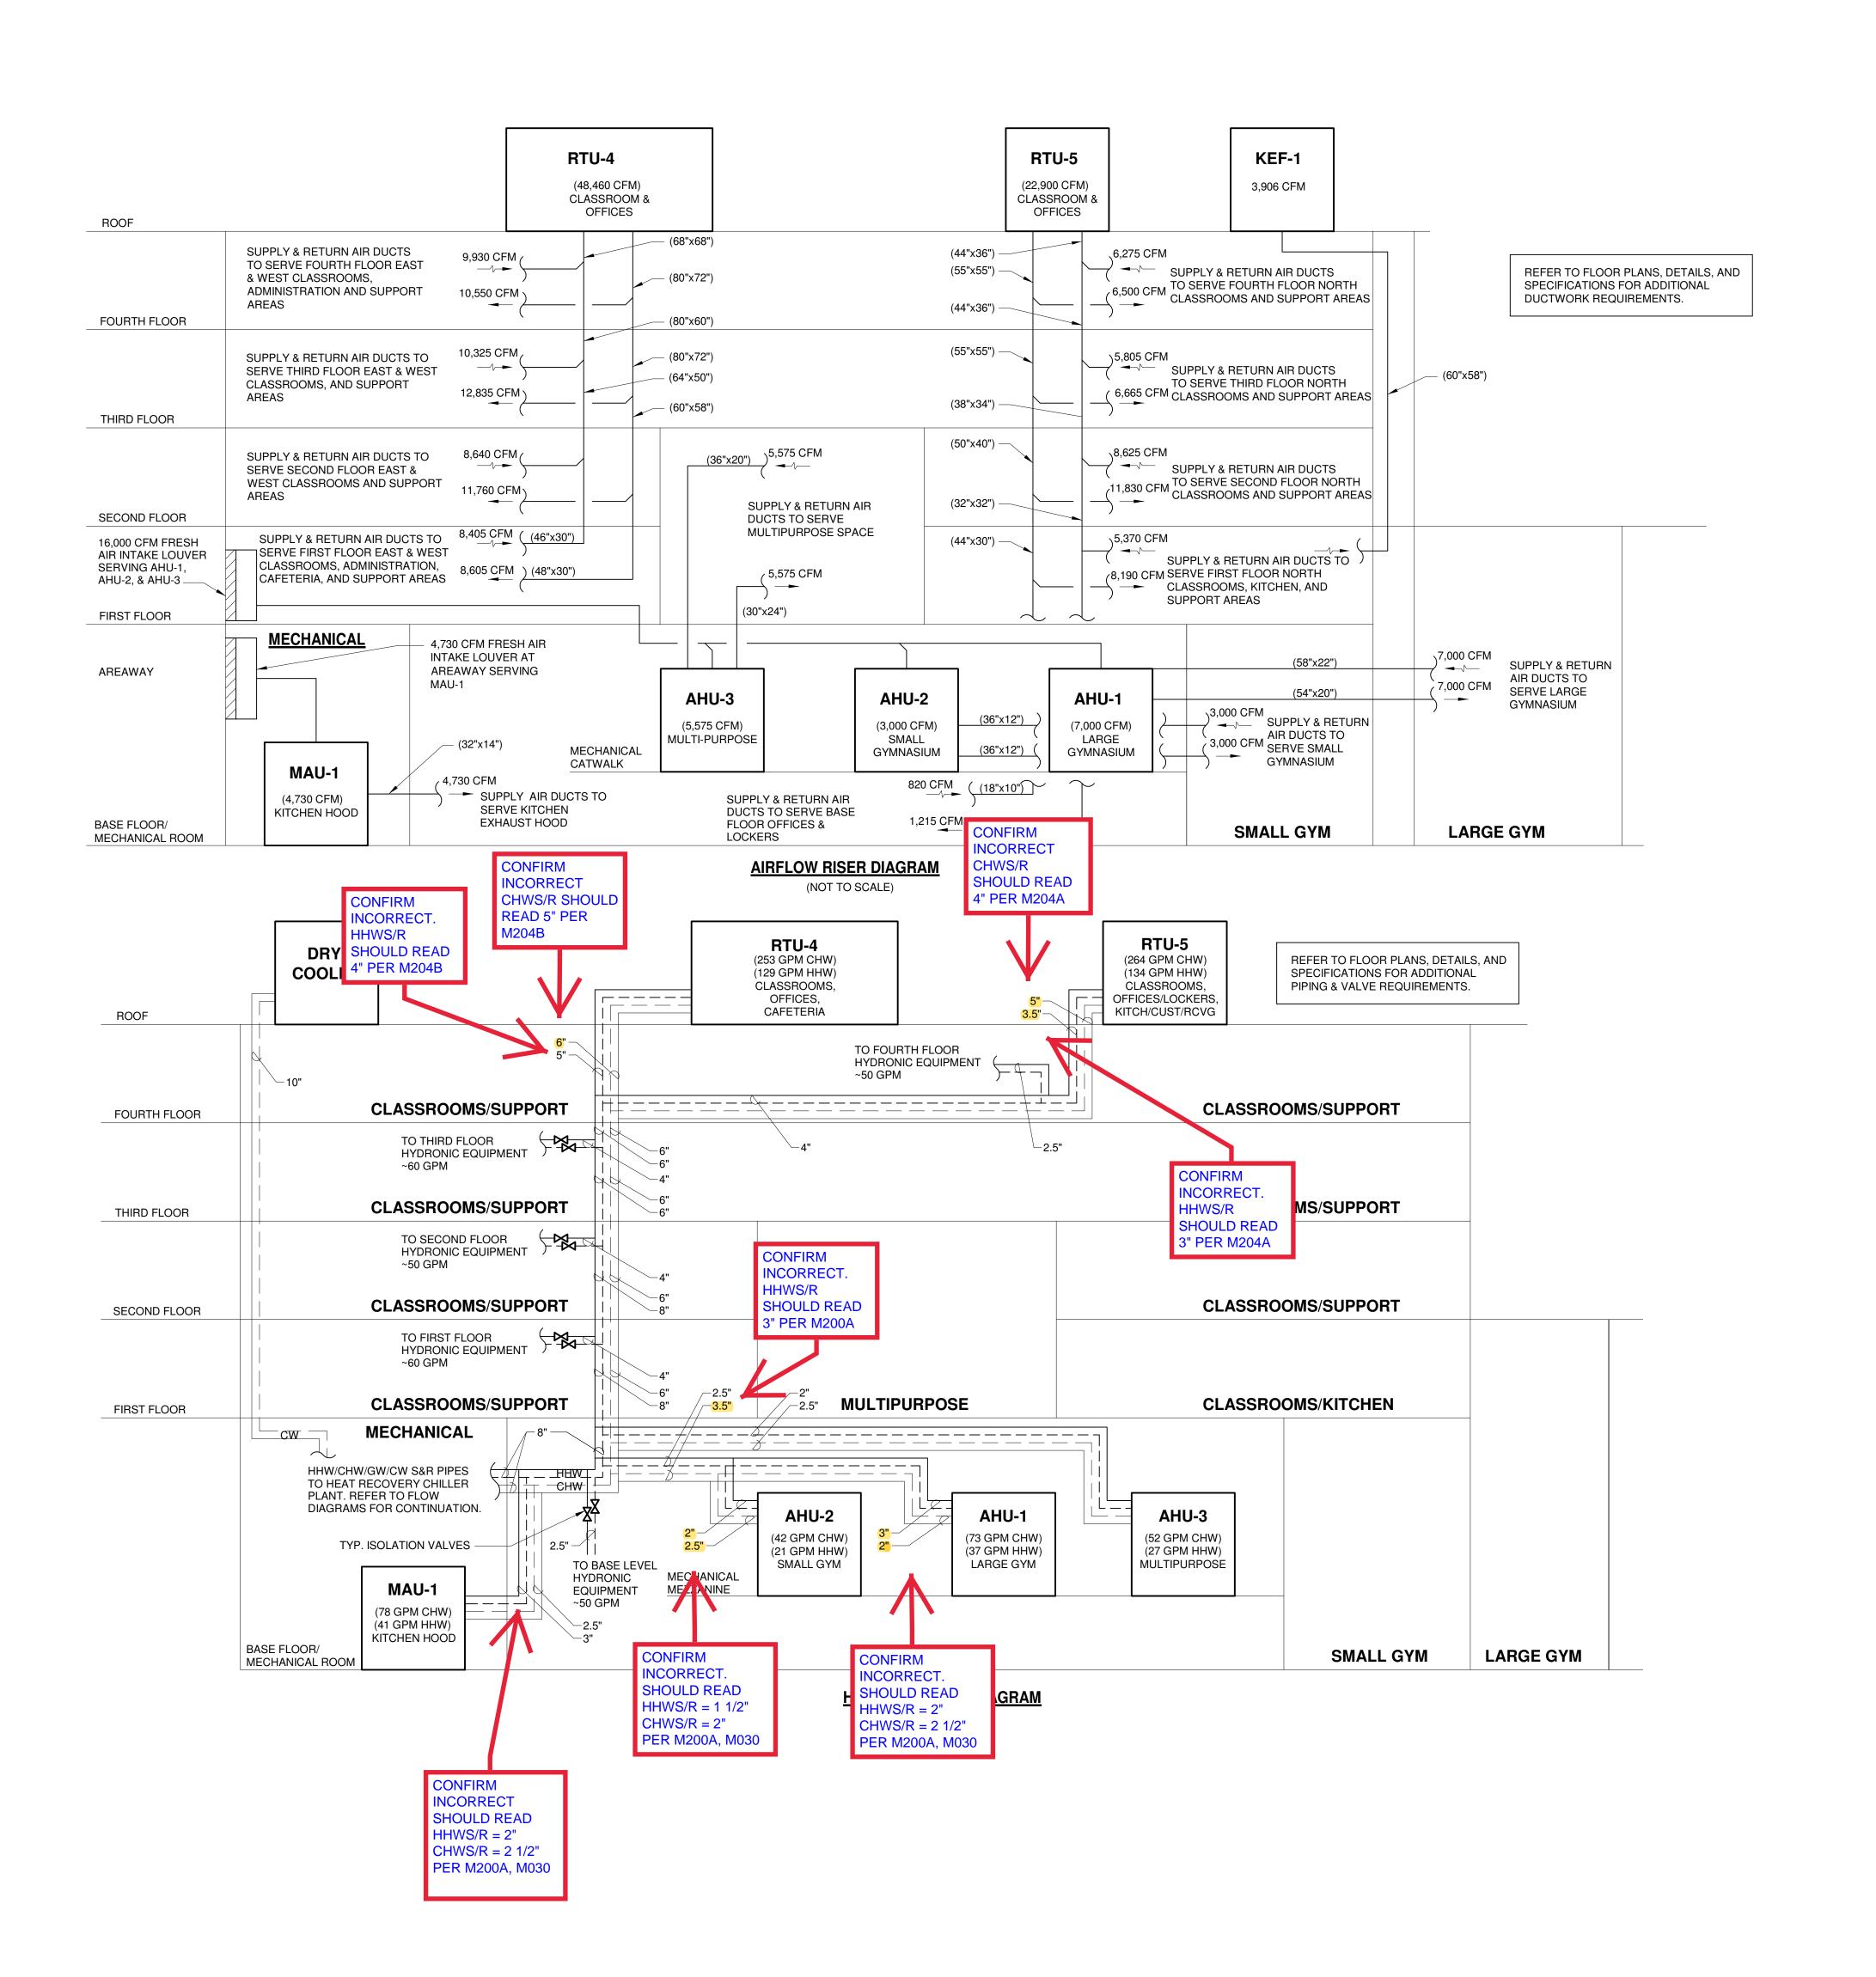







CHO S DRISC

PROJECT STATUS CONTRACT DOCUMENTS 4/16/21


REVISIONS

4 6/11/21 Conformance Set


DRAWING NAME HVAC - AIRFLOW AND HYDRONIC RISER DIAGRAM

PROJECT NO. Project Number DRAWING NO.

M021

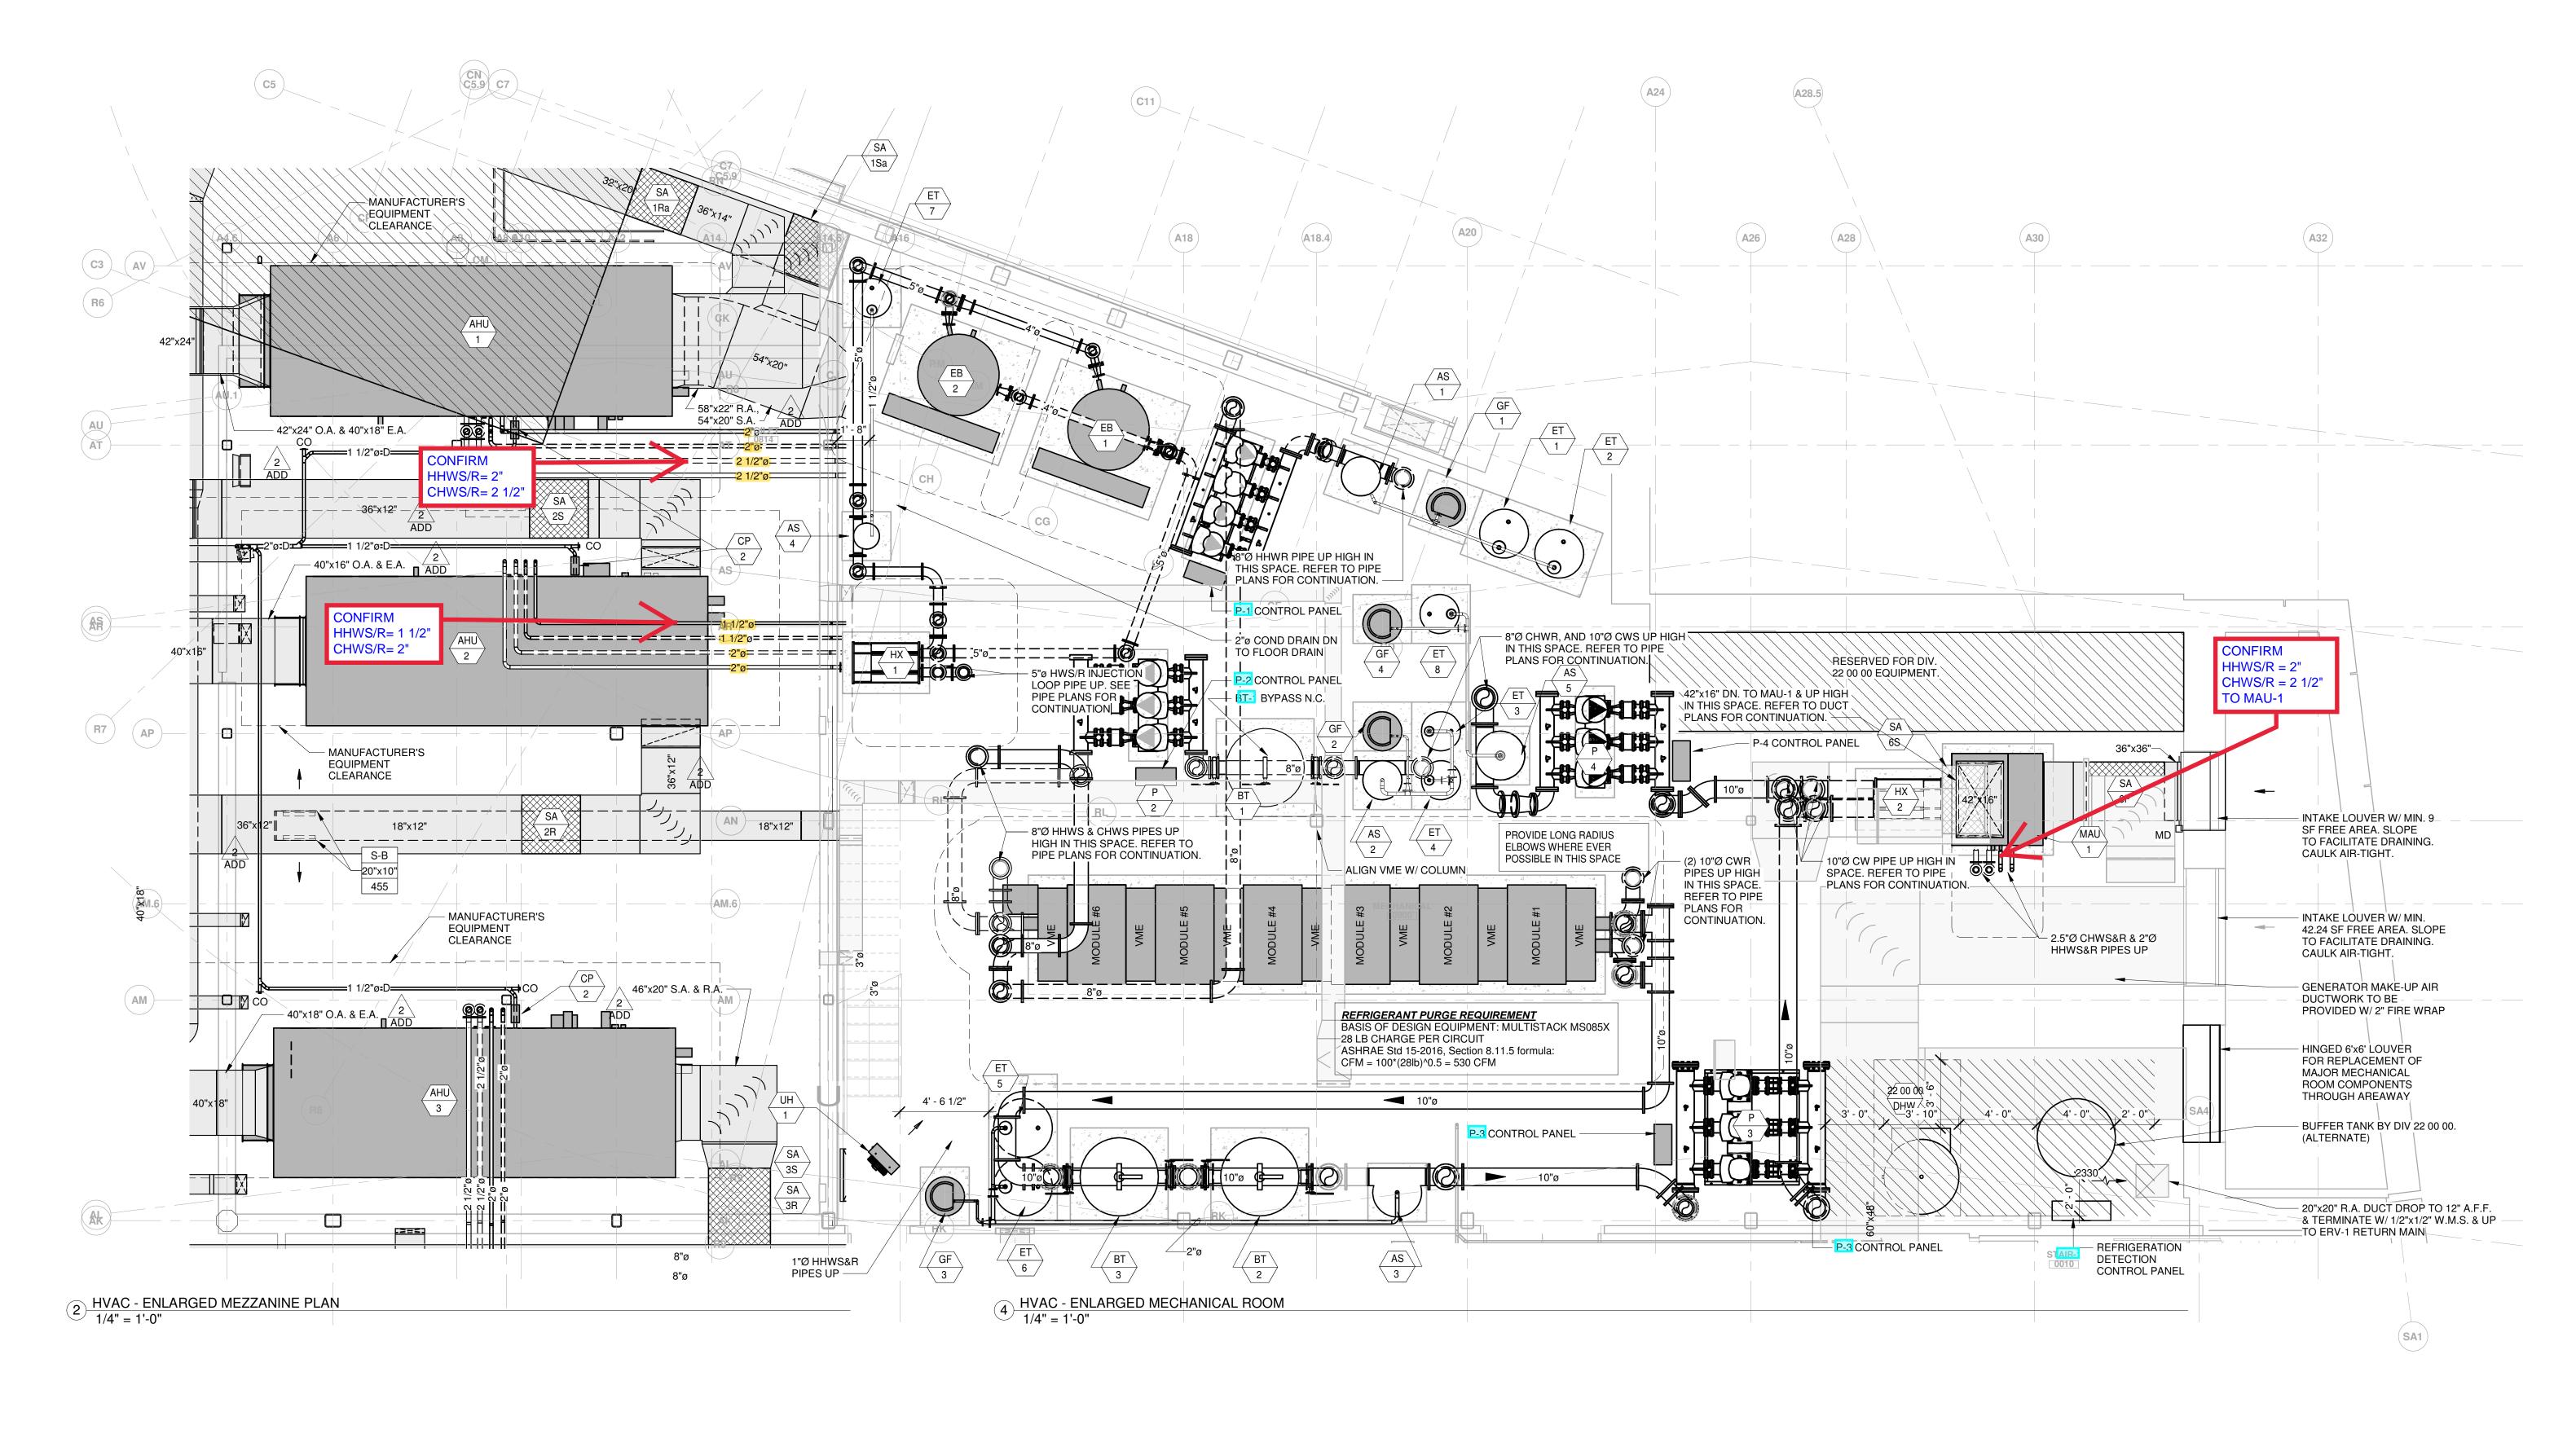

AG

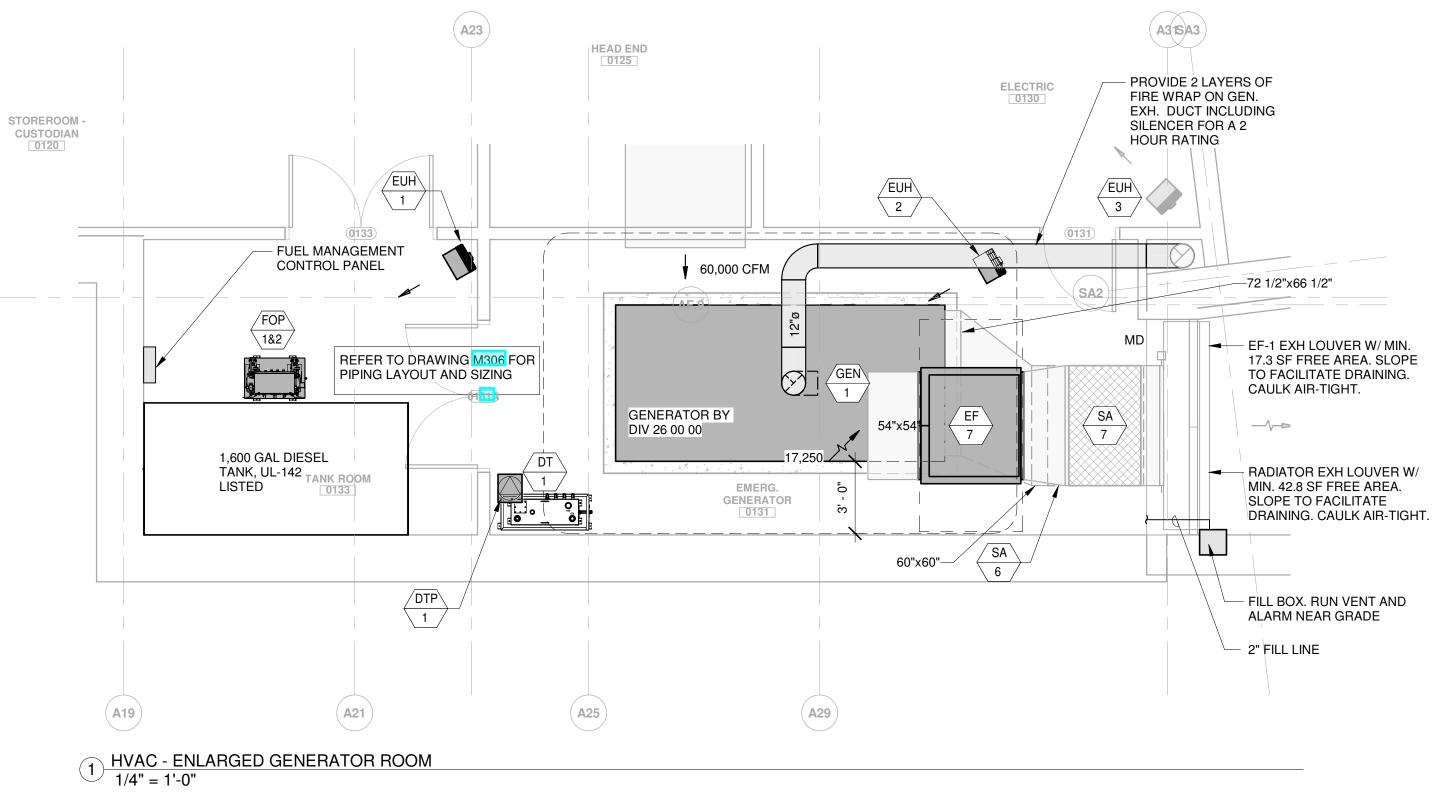



GARCIA GALUSKA DESOUSA
CONSULTING ENGINEERS
370 Faunce Corner Road, Dartmouth, MA
508 - 998 - 5700 FAX 508 - 998 - 0883 E - MAIL info@g - g - d . com

DRISCOLL SCHOOL

PROJECT STATUS

CONTRACT DOCUMENTS

4/16/21

REVISIONS

No. Date Description
2 5/5/21 Addendum 2
4 6/11/21 Conformance Set

DRAWING NAME

HVAC - ENLARGED

PROJECT NO. Project Number

DRAWING NO.

MECHANICAL

PLANS

M030

1 HVAC - BASE FLOOR PIPING PLAN - PART A 1/8" = 1'-0"





GARCIA GALUSKA DESOUSA
CONSULTING ENGINEERS INC.
370 Faunce Corner Road, Dartmouth, MA 02747 · 1271
508 · 998 · 5700 FAX 508 · 998 · 0883 E · MAIL info@g · g · d · com

DRISC

PROJECT STATUS

CONTRACT DOCUMENTS 4/16/21

REVISIONS

No. Date Description
4 6/11/21 Conformance Set

DRAWING NAME HVAC - BASE FLOOR PIPING PLAN - PART A

Jonathan Levi Architects 266 beacon street boston ma 02116 tel 617 437 9458 fax 617 437 1965



GARCIA GALUSKA DESOUSA
CONSULTING ENGINEERS
370 Faunce Corner Road, Dartmouth, MA
508 - 998 - 5700 FAX 508 - 998 - 0883 E - MAIL Info@g - g - d . com

SCHOOL DRISC

PROJECT STATUS

CONTRACT DOCUMENTS 4/16/21

REVISIONS No. Date Description
4 6/11/21 Conformance Set

DRAWING NAME HVAC - SECOND FLOOR PIPING PLAN - PART B

Jonathan Levi Architects 266 beacon street boston ma 02116 tel 617 437 9458 fax 617 437 1965



GARCIA GALUSKA DESOUSA
CONSULTING ENGINEERS
370 Faunce Corner Road, Dartmouth, MA
508 - 998 - 5700 FAX 508 - 998 - 0883 E - MAIL Info@g - g - d . com

DRISCOLL

PROJECT STATUS

CONTRACT DOCUMENTS 4/16/21

REVISIONS No. Date Description
4 6/11/21 Conformance Set

DRAWING NAME HVAC - THIRD FLOOR PIPING PLAN - PART B

1 HVAC - FOURTH FLOOR PIPING PLAN - PART A 1/8" = 1'-0"

266 beacon street boston ma 02116 tel 617 437 9458 fax 617 437 1965

GARCIA GALUSKA DESOUSA
CONSULTING ENGINEERS INC.
370 Faunce Corner Road, Dartmouth, MA 02747 · 1271
508 · 998 · 5700 FAX 508 · 998 · 0883 E · MAIL info@g · g · d · com

DRISC


PROJECT STATUS

CONTRACT DOCUMENTS 4/16/21

DRAWING NAME HVAC - FOURTH FLOOR PIPING PLAN - PART A

PROJECT NO. Project Number DRAWING NO.



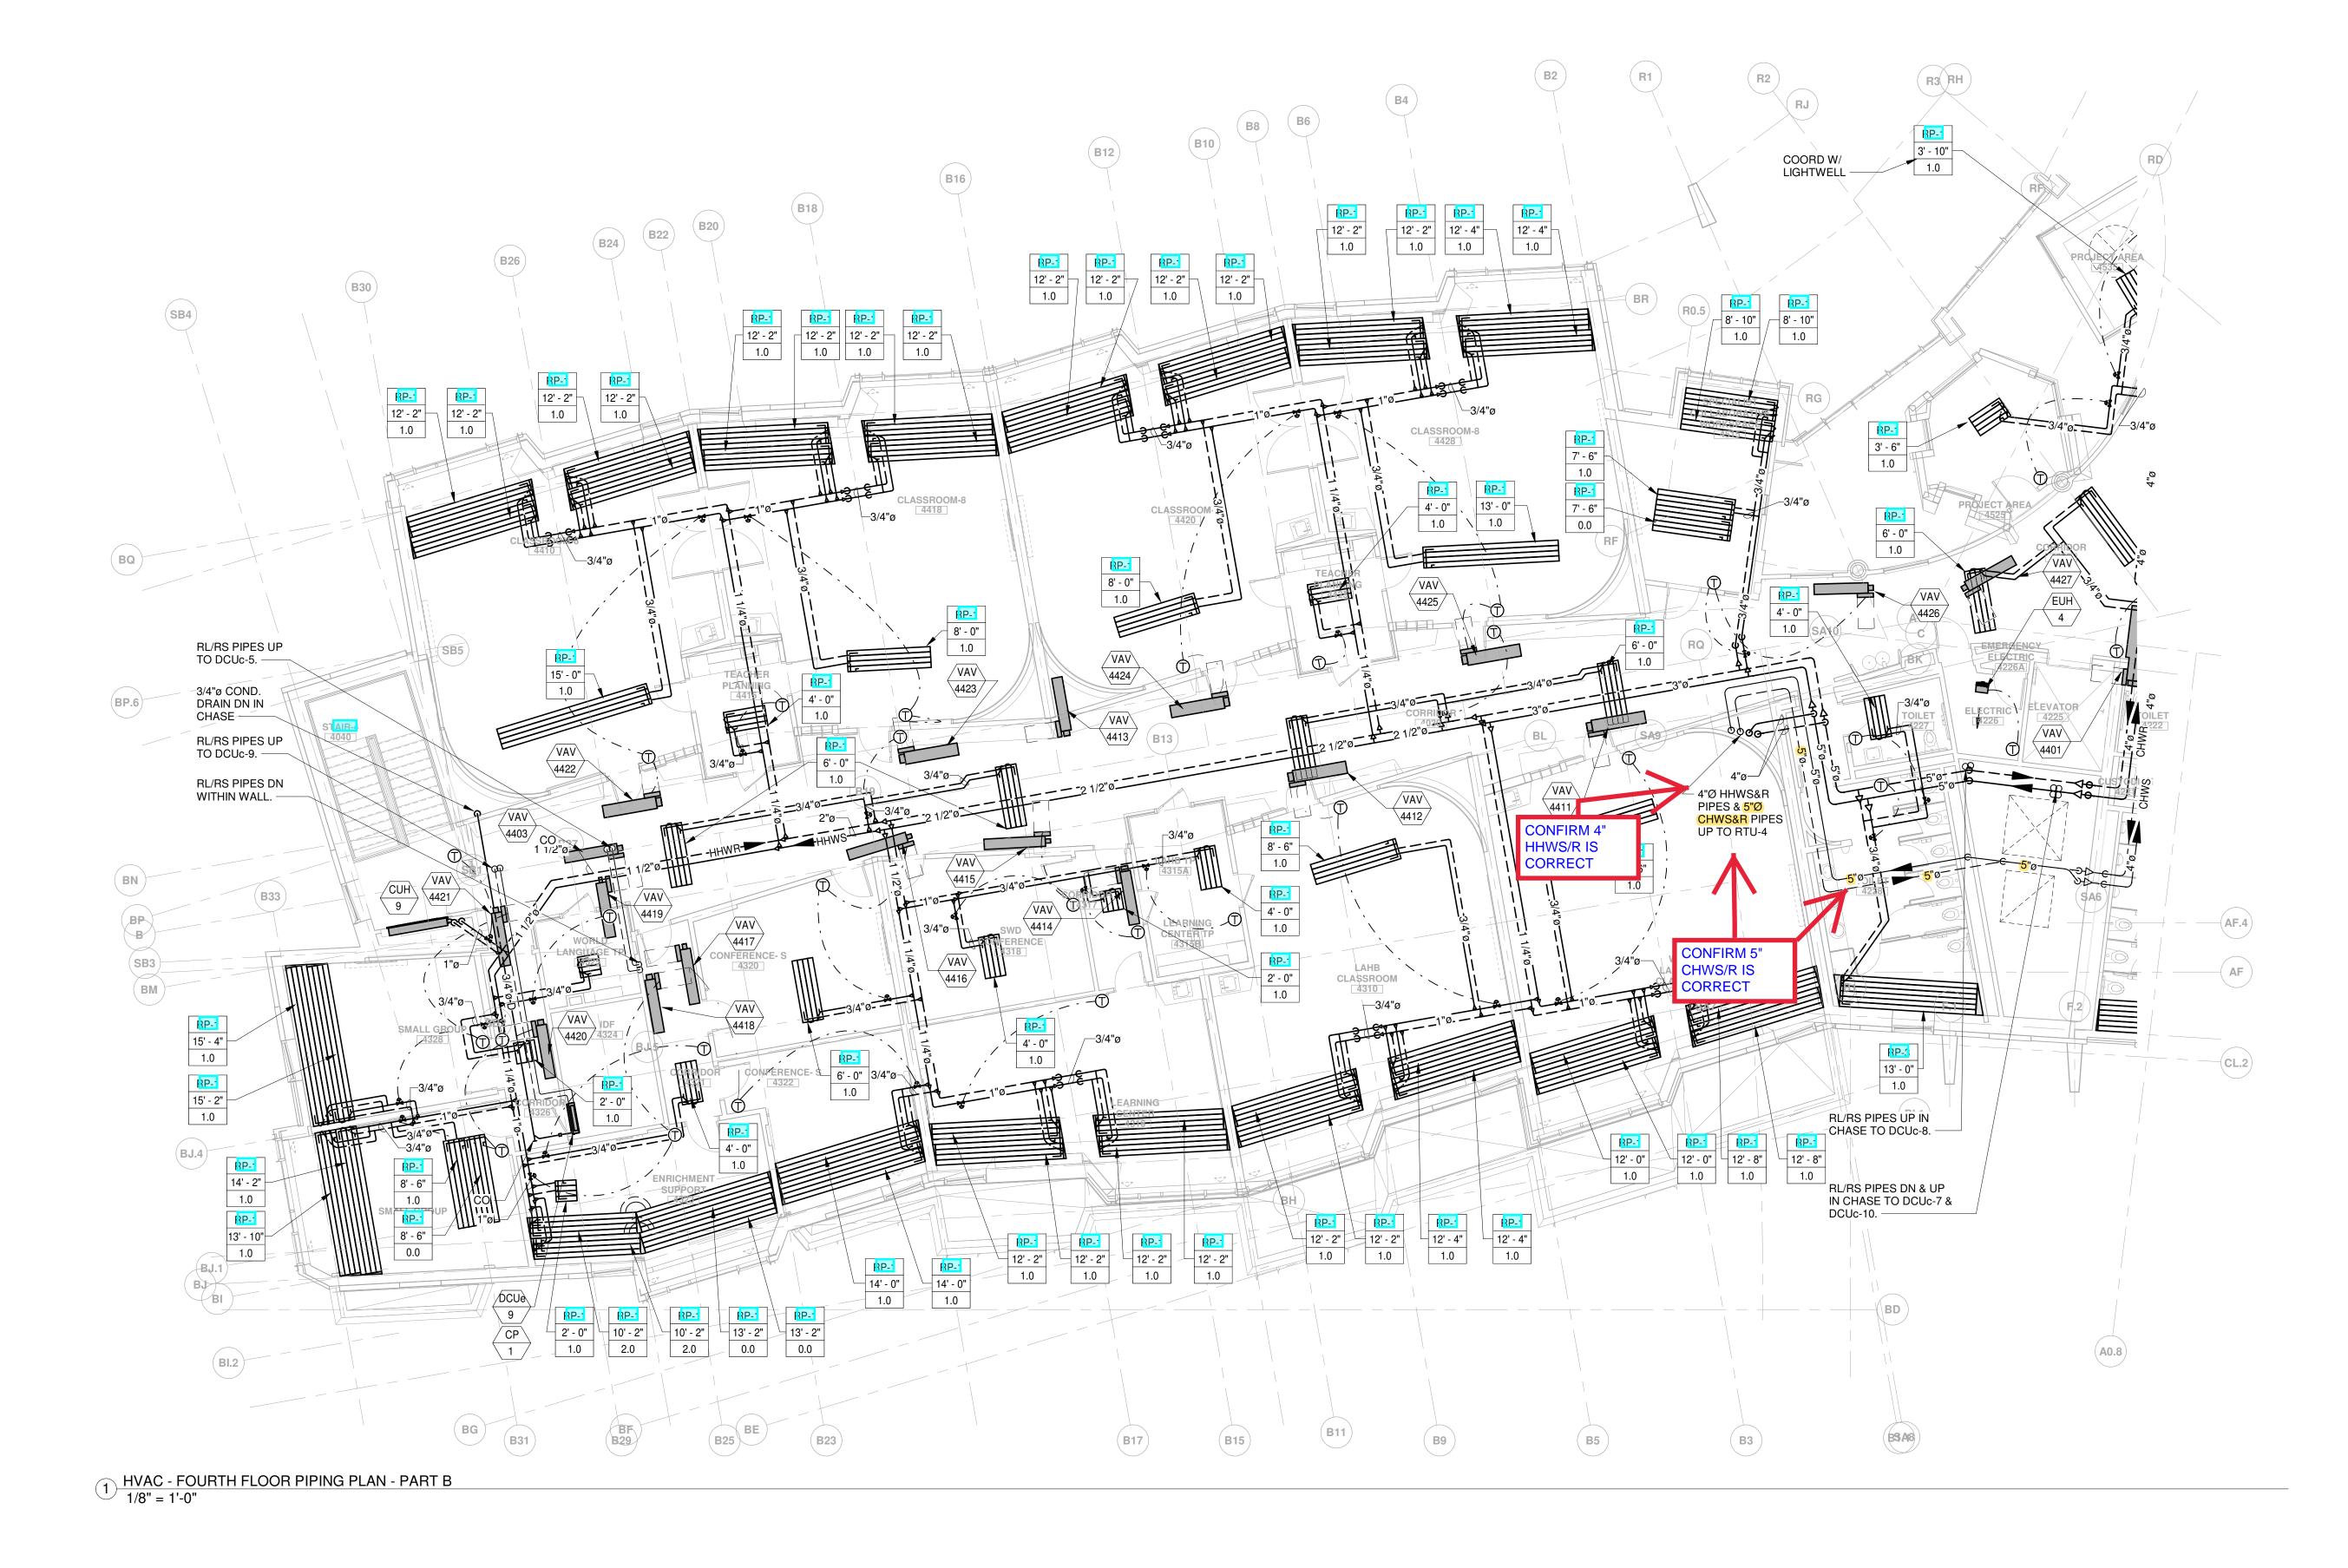



PROJECT STATUS CONTRACT DOCUMENTS

4/16/21

REVISIONS No. Date Description
4 6/11/21 Conformance Set

DRAWING NAME HVAC - FOURTH FLOOR PIPING PLAN - PART B



# Patrick J. Kennedy & Sons, Inc. MECHANICAL CONTRACTORS

Number: 3

REQUEST FOR INFORMATION

Date: 08/24/2021

Phone:

39 Gibson Street Boston, MA 02122-1222 Ph: (617)265-5535

Job: 2021-05 Driscoll School - HVAC

To:""Öolleen Shouldice

Gilbane Building Co Driscoll School

10 Channel Center St, Suite 10

Boston, MA 02120

CC:

Subject: HVAC Piping Size Clarifications

**Drawing:** M021, M030, M200A, M202B, M203B, **Spec Section:** 

M204A, M204B

Cost Impact: None Schedule Impact: None

Request: Date Required:

Dwg M021 HVAC Airflow and Hydronic Riser Diagram currently notes pipe sizes differing from the floor plans. Please review and confirm the following sizes as shown on the floor plans are correct:

RTU-4

CHWS/R is 5in per M204B HHWS/R is 4in per M204B

RTU-5

CHWS/R is 4in per M204A HHWS/R is 3in per M204A

AHU-1 & 2

HHWS/R Branch is 3in per M200A

AHU-1

CHWS/R is 2.5in per M200A, M030 HHWS/R is 2in per M200A, M030

AHU-2

CHWS/R is 2in per M200A, M030 HHWS/R is 1.5in per M200A, M030

MAU-1

CHWS/R is 2.5in per M200A HHWS/R is 2in per M200A

HHWS/R Riser at SA6 (M202B Markup)

Confirm Level 2 tagging should read HHWS/R 6in Up & 8in Down per M203B & M021

Requested by: Raymond Hanley

Patrick J. Kennedy & Sons, Inc



# Patrick J. Kennedy & Sons, Inc. MECHANICAL CONTRACTORS

Number: 3

Date: 08/24/2021

**REQUEST FOR INFORMATION** 

Phone:

39 Gibson Street Boston, MA 02122-1222 Ph: (617)265-5535


2021-05 Driscoll School - HVAC

To: colleen Shouldice Gilbane Building Co Driscoll School

10 Channel Center St, Suite 10

Boston, MA 02120

Answered by  Company  Date	Response:	
Company Date	Answered by	
	Company	Date

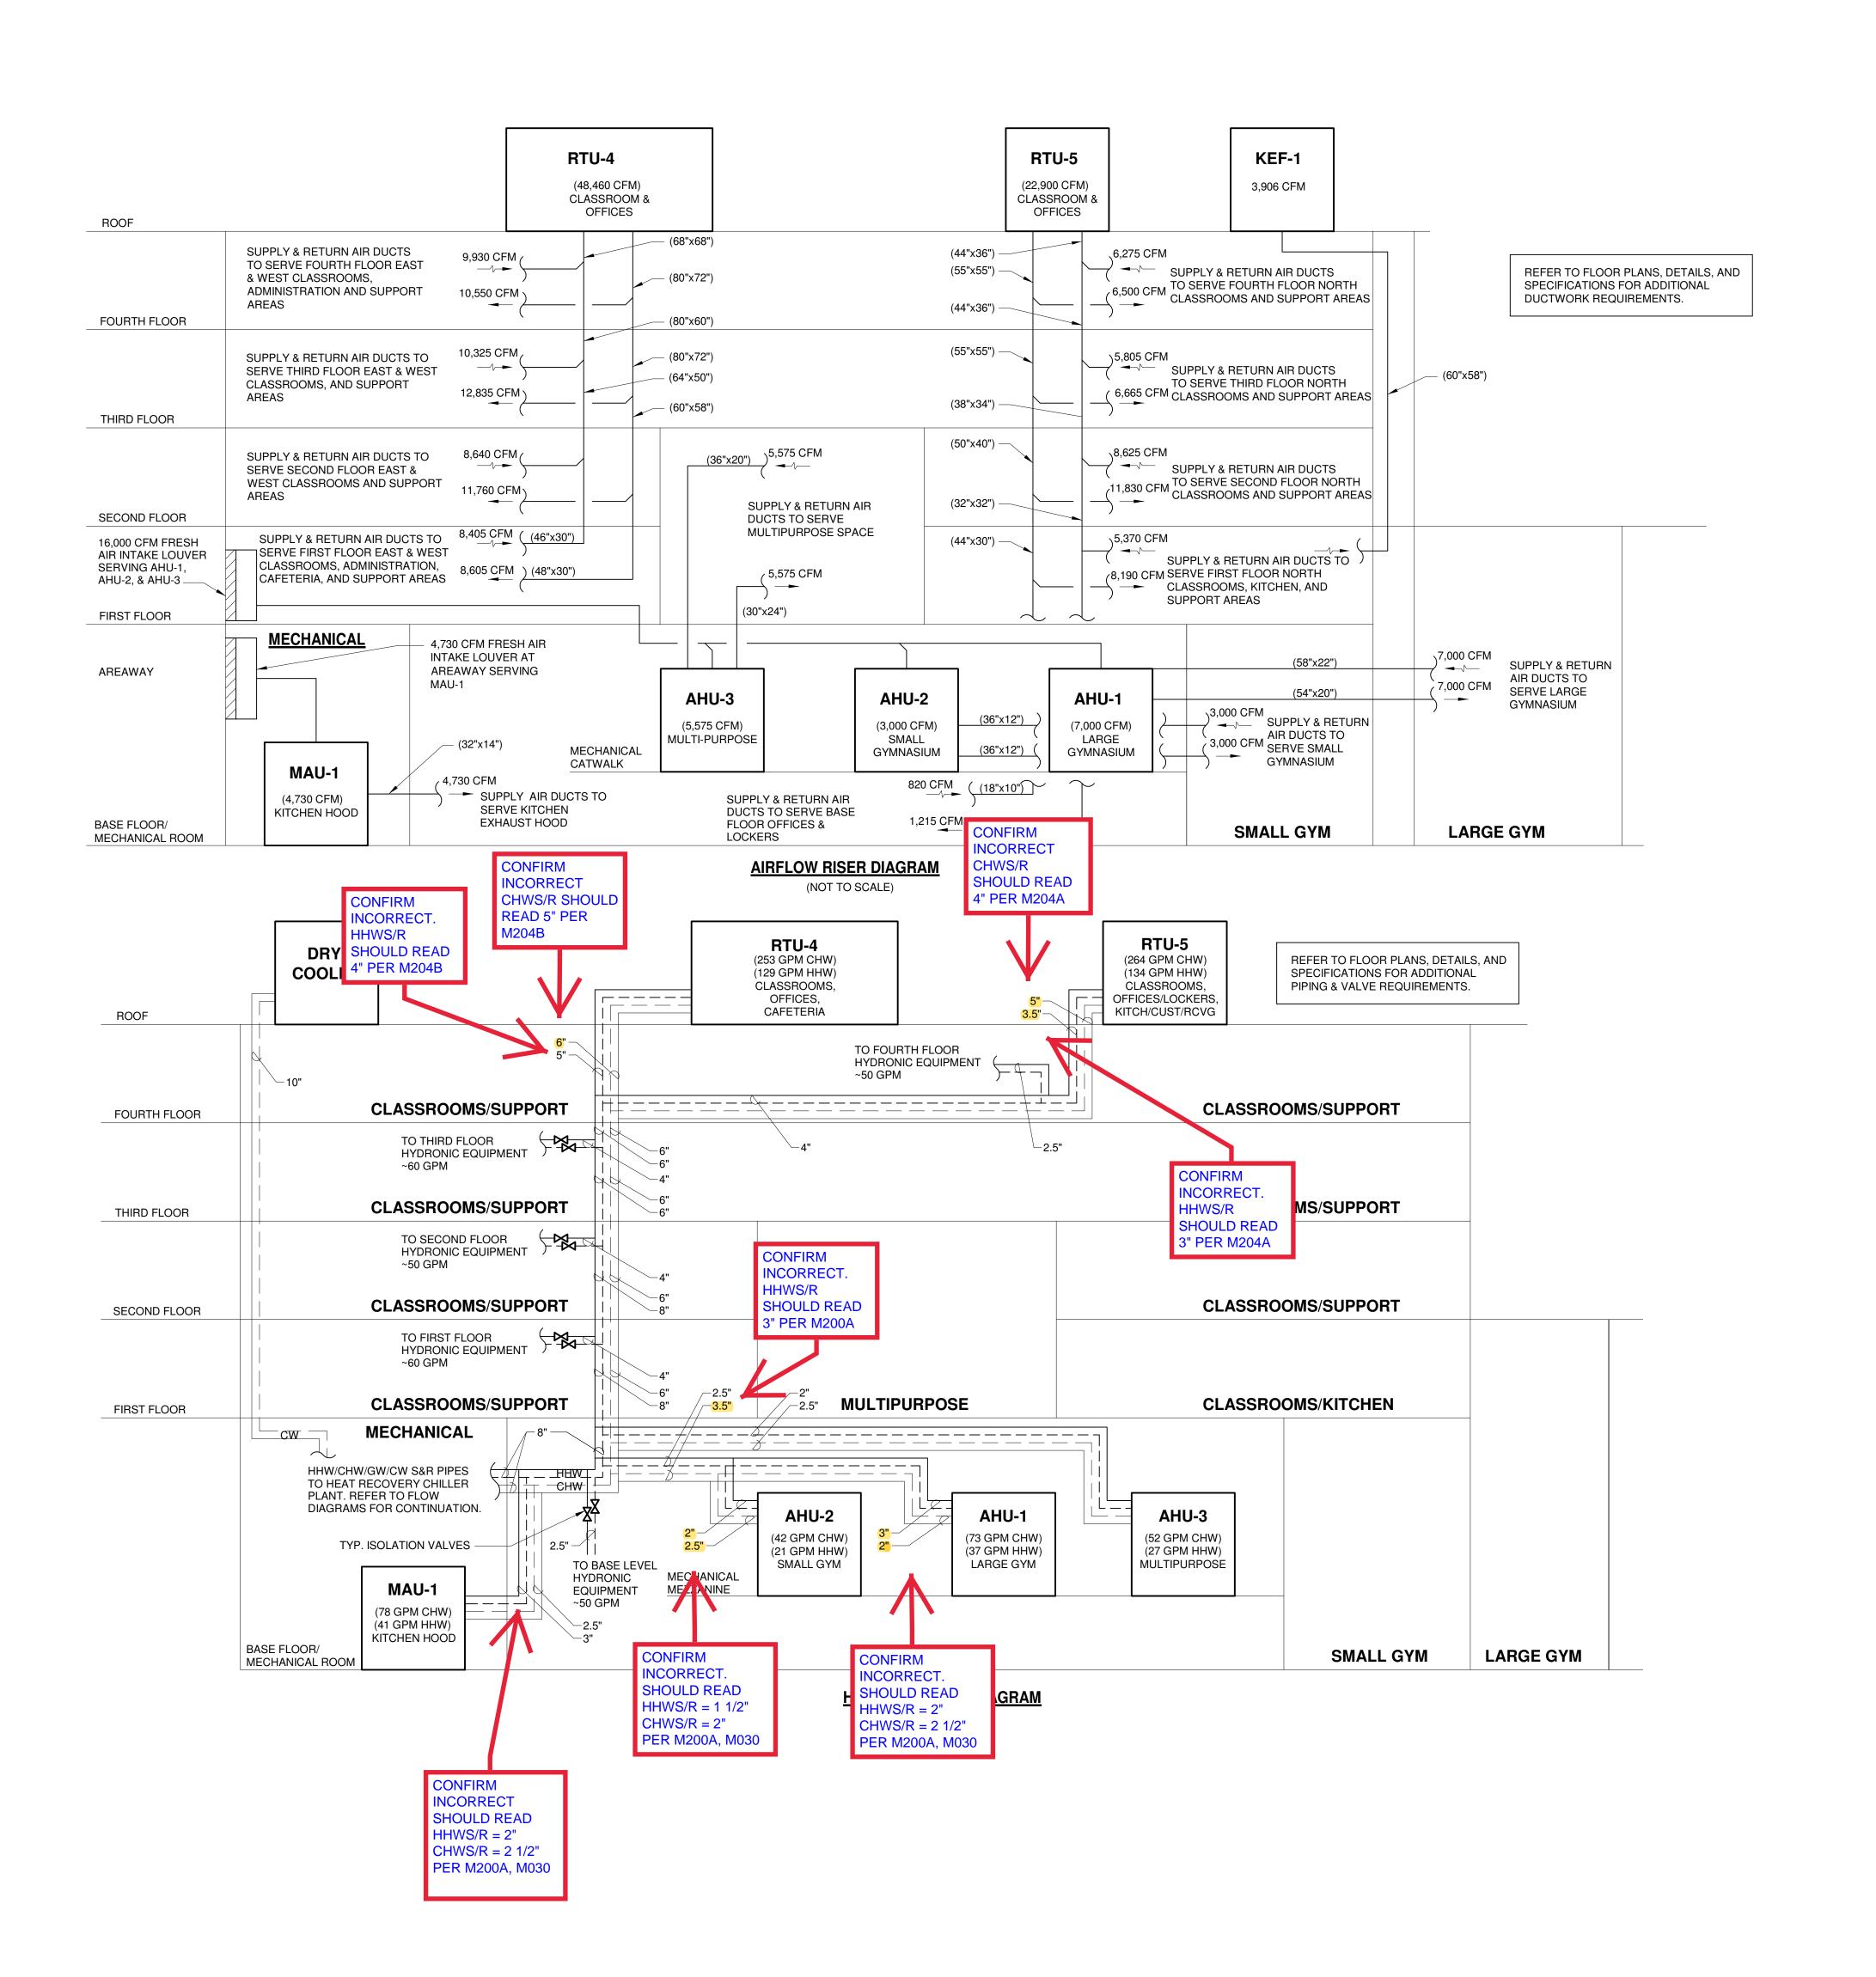







CHO S DRISC

PROJECT STATUS CONTRACT DOCUMENTS 4/16/21


REVISIONS

4 6/11/21 Conformance Set


DRAWING NAME HVAC - AIRFLOW AND HYDRONIC RISER DIAGRAM

PROJECT NO. Project Number DRAWING NO.

M021

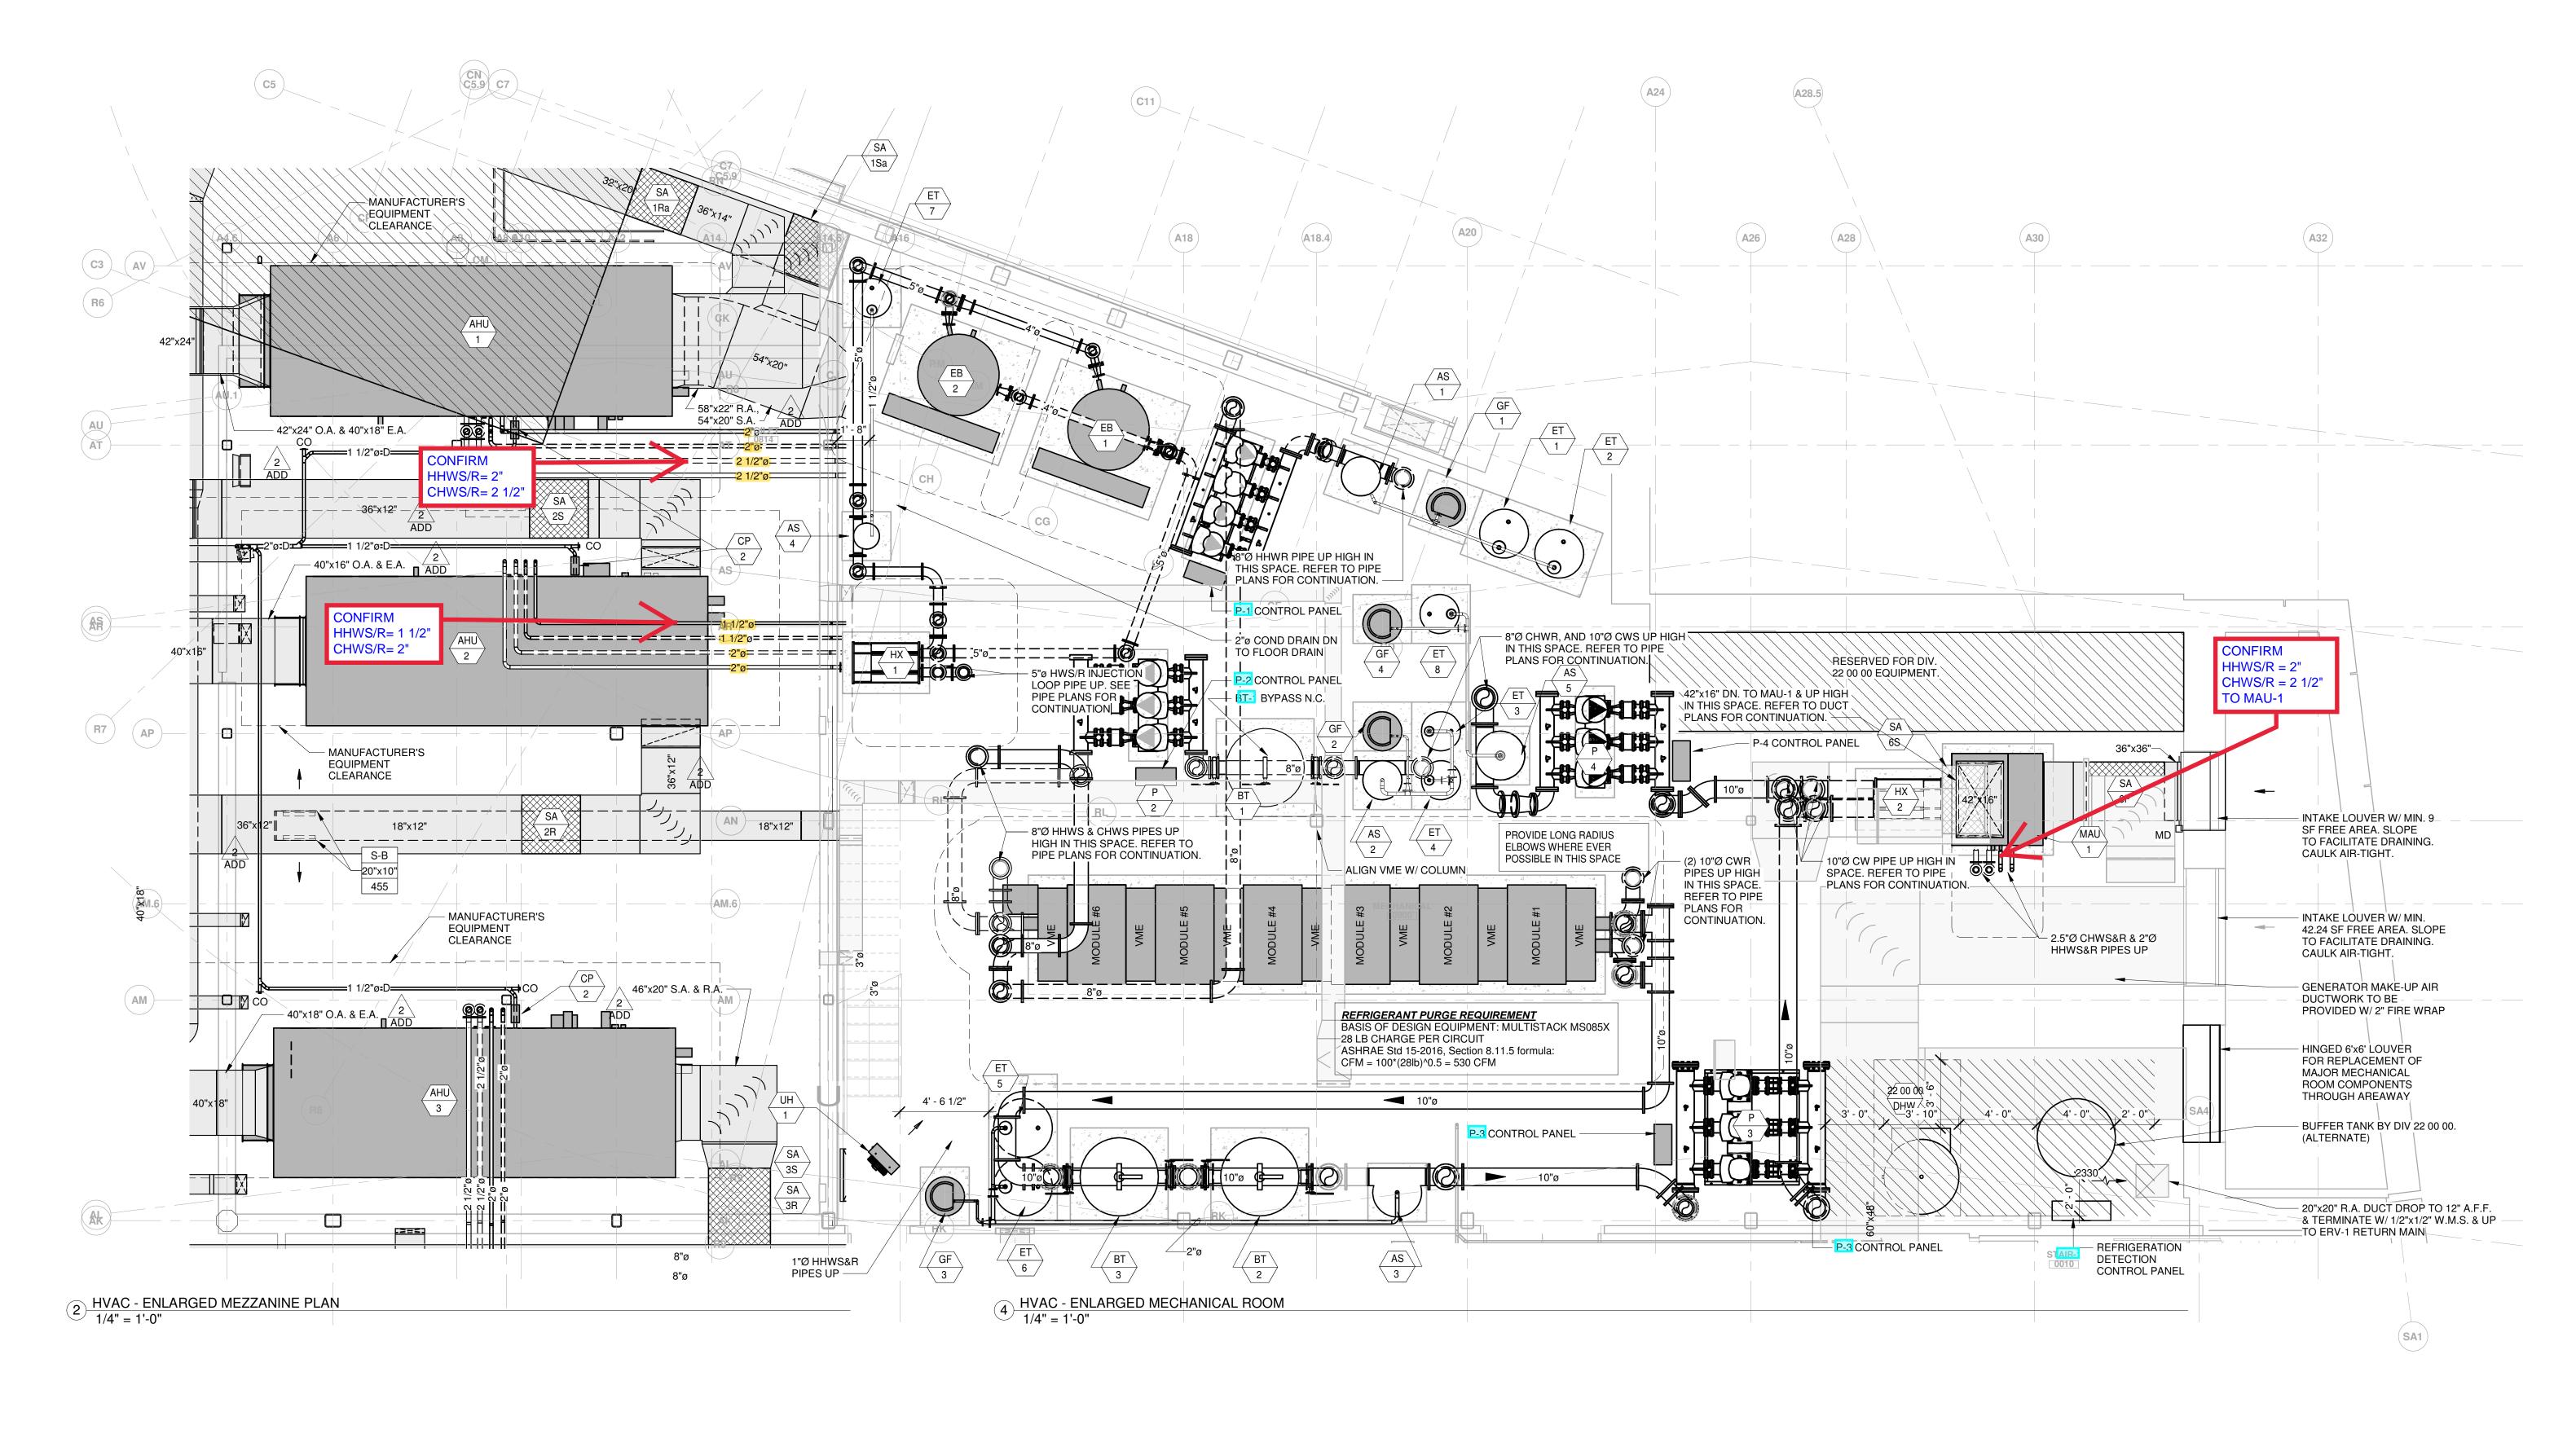

AG

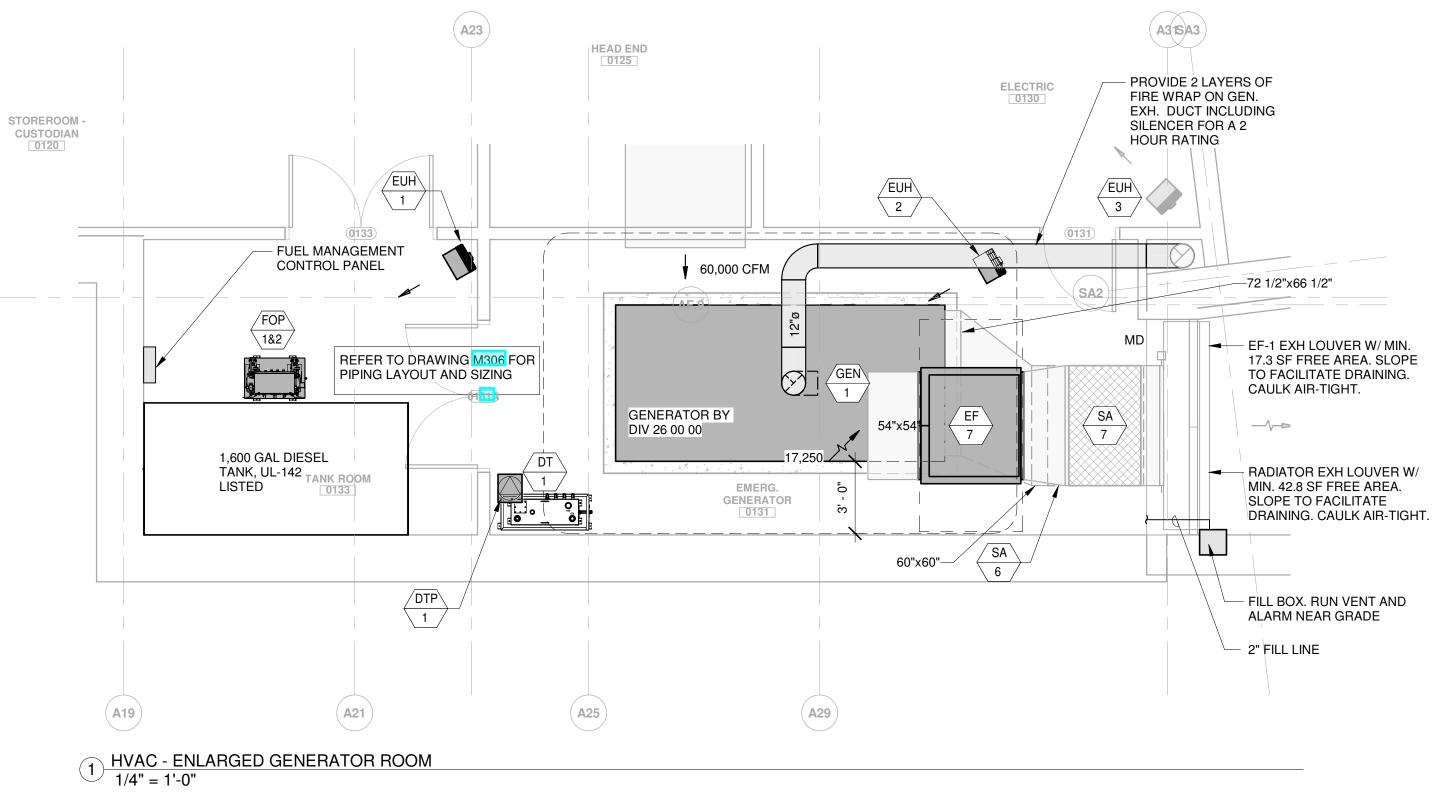



GARCIA GALUSKA DESOUSA
CONSULTING ENGINEERS
370 Faunce Corner Road, Dartmouth, MA
508 - 998 - 5700 FAX 508 - 998 - 0883 E - MAIL info@g - g - d . com

DRISCOLL SCHOOL

PROJECT STATUS

CONTRACT DOCUMENTS

4/16/21

REVISIONS

No. Date Description
2 5/5/21 Addendum 2
4 6/11/21 Conformance Set

DRAWING NAME

HVAC - ENLARGED

PROJECT NO. Project Number

DRAWING NO.

MECHANICAL

PLANS

M030

1 HVAC - BASE FLOOR PIPING PLAN - PART A 1/8" = 1'-0"





GARCIA GALUSKA DESOUSA
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370 Faunce Corner Road, Dartmouth, MA 02747 · 1271
508 · 998 · 5700 FAX 508 · 998 · 0883 E · MAIL info@g · g · d · com

DRISC

PROJECT STATUS

CONTRACT DOCUMENTS 4/16/21

REVISIONS

No. Date Description
4 6/11/21 Conformance Set

DRAWING NAME HVAC - BASE FLOOR PIPING PLAN - PART A

Jonathan Levi Architects 266 beacon street boston ma 02116 tel 617 437 9458 fax 617 437 1965



GARCIA GALUSKA DESOUSA
CONSULTING ENGINEERS
370 Faunce Corner Road, Dartmouth, MA
508 - 998 - 5700 FAX 508 - 998 - 0883 E - MAIL Info@g - g - d . com

SCHOOL DRISC

PROJECT STATUS

CONTRACT DOCUMENTS 4/16/21

REVISIONS No. Date Description
4 6/11/21 Conformance Set

DRAWING NAME HVAC - SECOND FLOOR PIPING PLAN - PART B

Jonathan Levi Architects 266 beacon street boston ma 02116 tel 617 437 9458 fax 617 437 1965



GARCIA GALUSKA DESOUSA
CONSULTING ENGINEERS
370 Faunce Corner Road, Dartmouth, MA
508 - 998 - 5700 FAX 508 - 998 - 0883 E - MAIL Info@g - g - d . com

DRISCOLL

PROJECT STATUS

CONTRACT DOCUMENTS 4/16/21

REVISIONS No. Date Description
4 6/11/21 Conformance Set

DRAWING NAME HVAC - THIRD FLOOR PIPING PLAN - PART B

266 beacon street boston ma 02116 tel 617 437 9458 fax 617 437 1965

GARCIA GALUSKA DESOUSA
CONSULTING ENGINEERS INC.
370 Faunce Corner Road, Dartmouth, MA 02747 · 1271
508 · 998 · 5700 FAX 508 · 998 · 0883 E · MAIL info@g · g · d · com


DRISC

PROJECT STATUS

CONTRACT DOCUMENTS 4/16/21

DRAWING NAME HVAC - FOURTH FLOOR PIPING PLAN - PART A

> PROJECT NO. Project Number DRAWING NO.

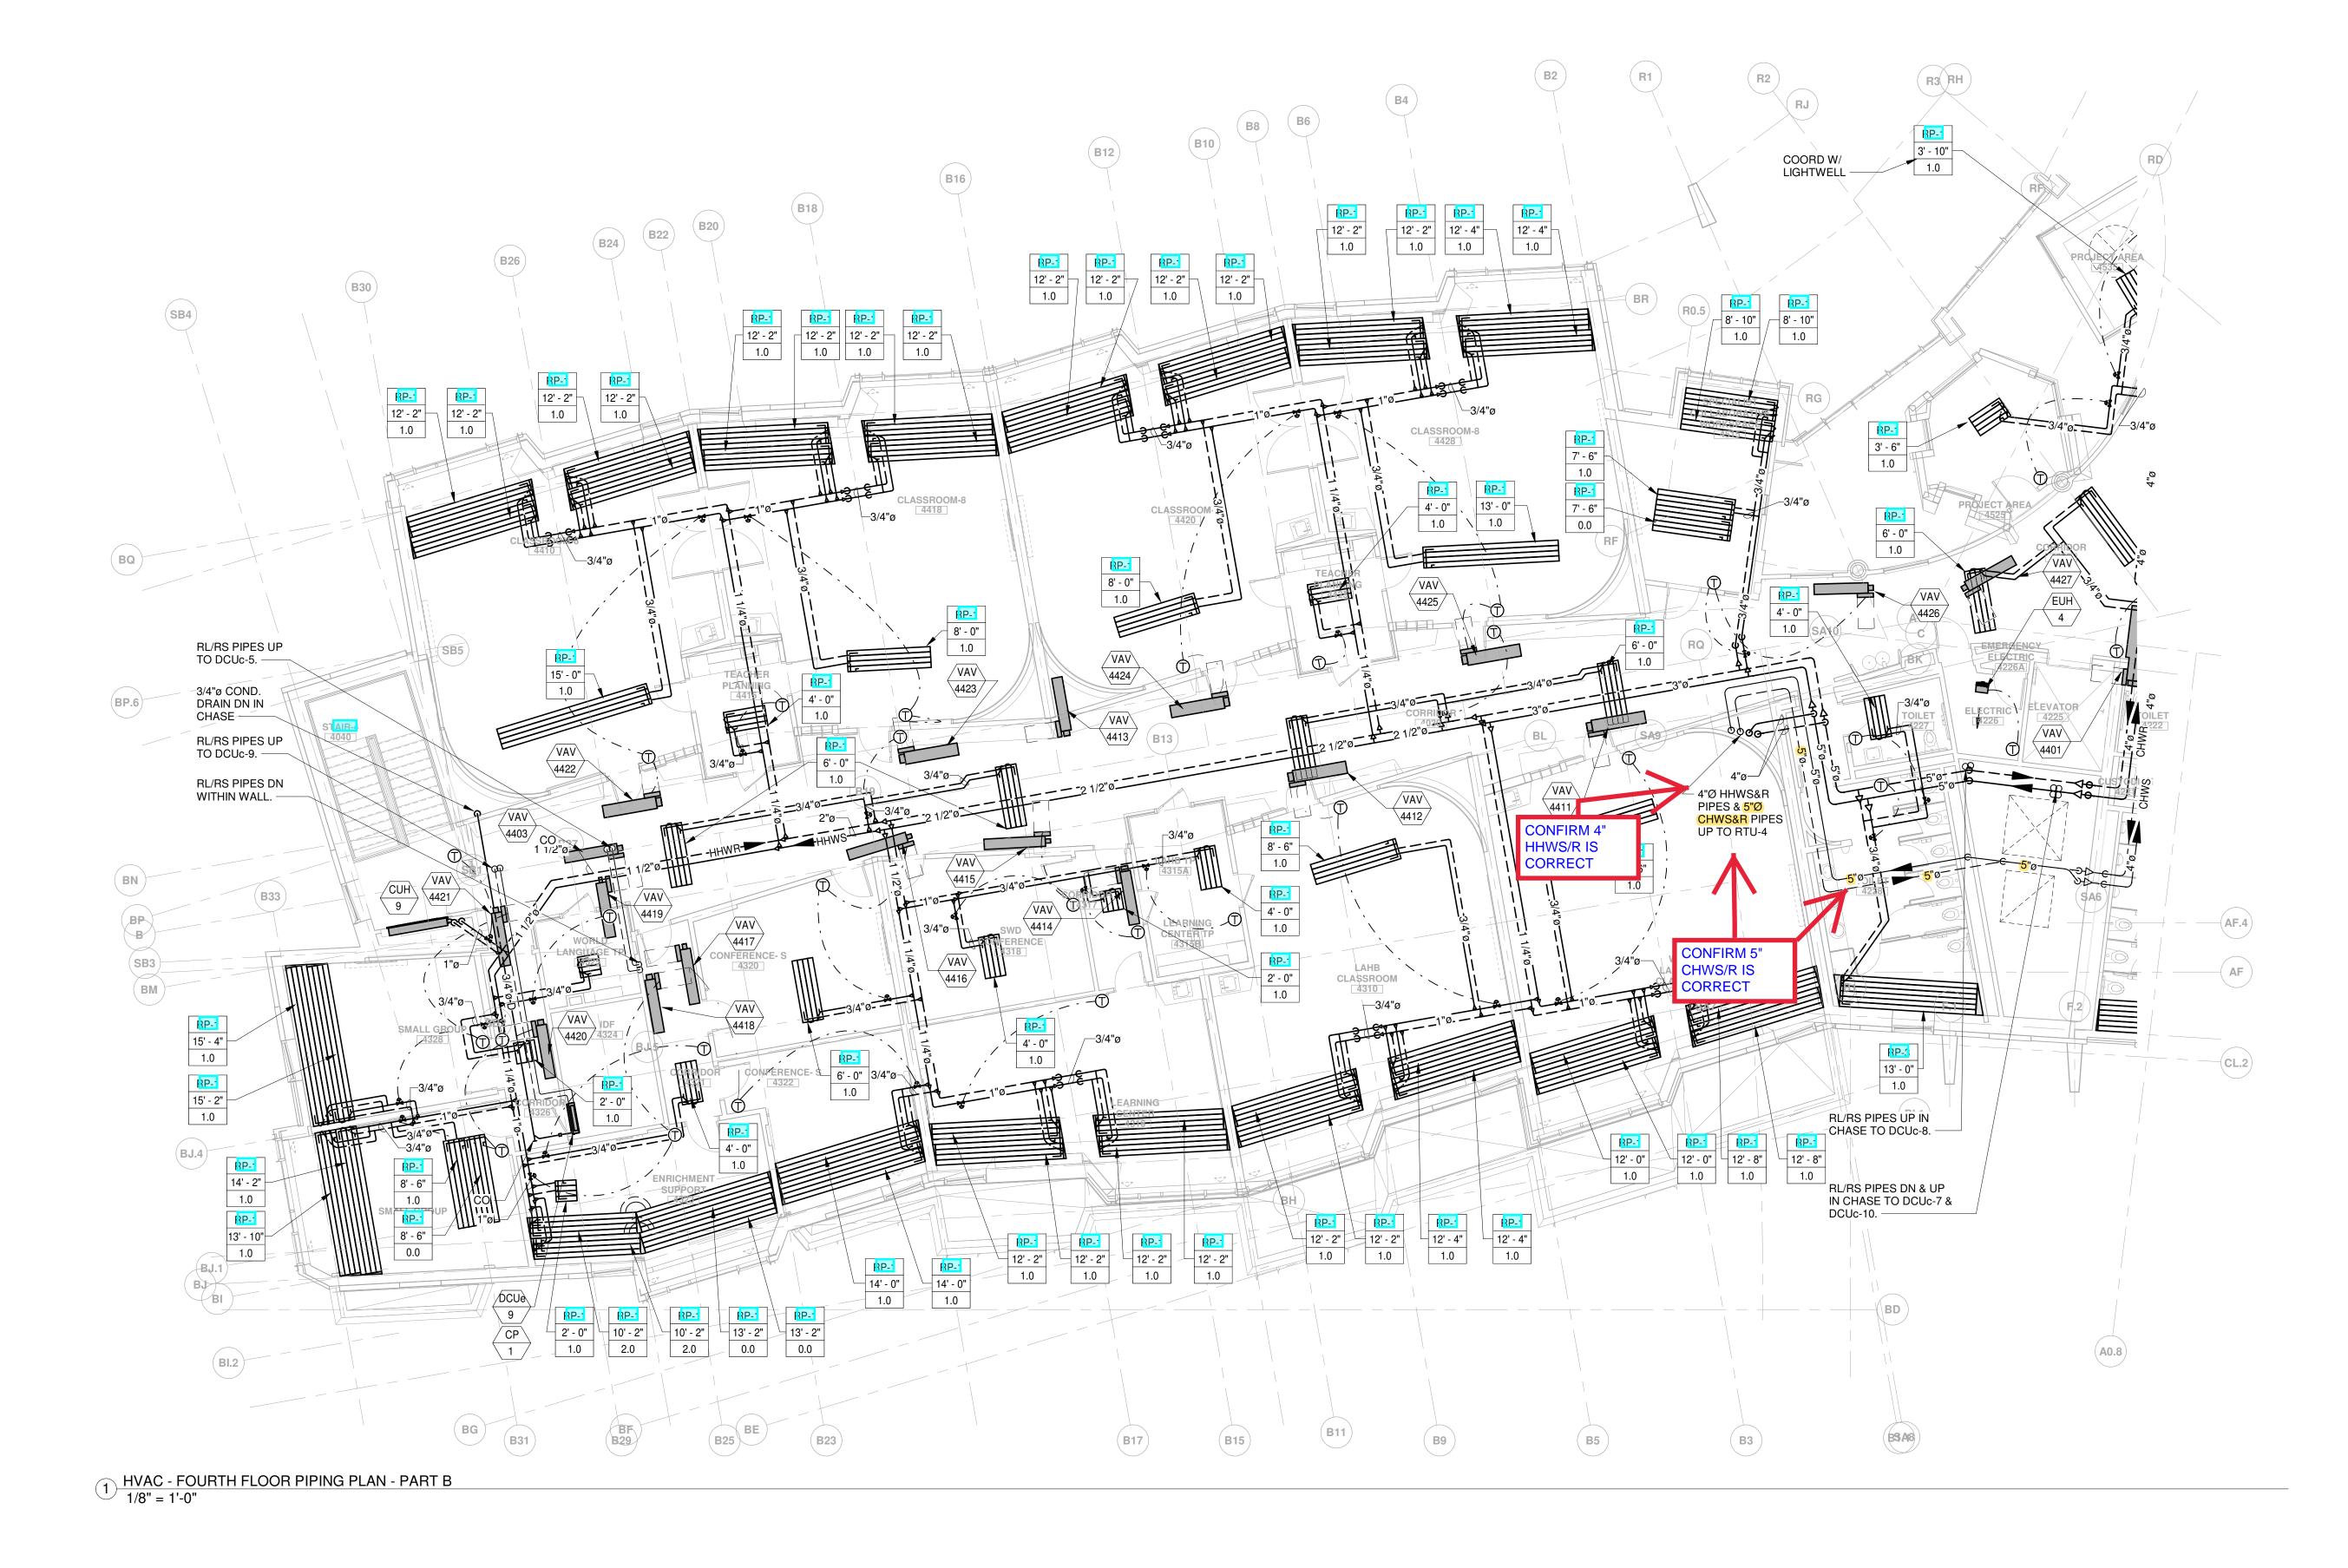



PROJECT STATUS CONTRACT DOCUMENTS

4/16/21

REVISIONS No. Date Description
4 6/11/21 Conformance Set

DRAWING NAME HVAC - FOURTH FLOOR PIPING PLAN - PART B

#### Gilbane Building Company **Authorization To Proceed**



CONTRACT FOR: Brookline - Driscoll School

OWNER: Town of Brookline ADDRESS: 333 Washington Street

Brookline, MA, 02445

ARCHITECT: Jonathan Levi Architects LLC, Mark Warner

PROJECT NUMBER: ATP NO: ATP VERSION: DATE OF ISSUANCE:

SUBMITTED BY:

12/14/2021 Gilbane Building Company

J08864.000

ATP-0025

**ALTERNATE** TRACKING #:

The Contract Documents are hereby amended to include the additional Work described below, which is outside of the current scope of the Work and constitutes a change.

Upon Owner approval, Gilbane Building Company will proceed with the Work promptly.

Costs as incurred are in addition to the current contract Sum and will be invoiced and paid on a monthly basis and identified as separate items within the requisition. Once final cost of the Work involved and change in Sum and Time (if any) are fully determined, it will be submitted for inclusion in a final Change Order adjusting the Contract Sum and/or Time.

TITLE: ASI #8 Gridlines SC1 and AU.1

DESCRIPTION: This ATP represents cost to add ASI #8 dated 10/22/2021 has been incorporated into the contract at No Cost.

#### Attachments:

Number	Description:	PCI Number	Change Date	Revision
00205764		OS-00027	12/14/2021	Original Version

The Following information is provided by Gilbane Building Company

#### Method of determining change in Contract:

	Cost Plus Fee	■ Unit Price	Lump Sum
Other			

Change In Contract Sum Dollar Amount: \$.00

 ■ Estimated ■ Time and Material Fixed 

> Change In Contract Time Time (Days): TBD

√ Fixed 

Job	PCI No.	Description	Phase Code	SubContractor	Amount	Accept?
J08864.000	OS-00027	Cast-In-Place Concrete		Marguerite Concrete Contractors, Inc	\$.00	C Yes C No

Job	PCI No.	Description	Phase Code	SubContractor	Amount	Accept?
J08864.000	OS-00027	Structural Steel	01.05A.060000.I	Supermetal Structures Inc.	\$.00	C Yes C No
J08864.000	OS-00027	Curtainwall	01.08A.084003.E	Salem Glass Company	\$.00	C Yes C No
J08864.000	OS-00027	Sitework	01.31A.311000.X	J. Derenzo Company	\$.00	C Yes C No
J08864.000	OS-00027	Gen & Excess Liability Insurance	99.970.950050.Z		\$.00	C Yes C No
J08864.000	OS-00027	Performance & Payment Bond	99.970.997000.Z		\$.00	C Yes C No
J08864.000	OS-00027	Subcontractor Default Insurance	99.975.996000.Z		\$.00	C Yes C No
J08864.000	OS-00027	Fee	99.999.999000.Z		\$.00	C Yes C No
TOTAL FOR PCI No.	OS-00027	\$0.00				

Submitted Amt: \$.00

Silbane Building Company	3ilbane	Building	Company	V
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#### Gilbane Building Company

Signed: 12/15/2021 1:58:54 PM Eastern Standard Time - By: Lynda Callahan (Senior Project Manager )

Gilbane Building Company: 10.126.8.52

onathan Levi Architects LLC

By: Carol Harris

Title: Project Manager

company: Jonathan Levi Architects

Date: 12/15/21

Printed Name: Carol Harris

.EFTFIELD, LLC

By: Lynn Stapleton

Title: OPM

company: LeftField Project Management

Date: 12/15/21

Printed Name: Lynn Stapleton

own of Brookline

REVIEWED

By:

Title:

Company: T, 0, B,

Date: 16 DECEMBER 2021

Printed Name: ANTHONY G-VICLI

Ε

Ε

#### ARCHITECTURAL SUPPLEMENTAL INFORMATION

project Driscoll School project no. 1823

date of issuance October 22, 2021

distribution Tony Guigli, Walter Kinkaid, Lynda Callahan, Derek Ullman,

Jim Rogers, Lynn Stapleton, Jen Carlson, Adam Keane, Matt

Casey, Mark Warner, Carol Harris

asi no. 008

re Gridlines SC1 and AU.1

The work shall be carried out in accordance with the supplemental instructions described herein issued in accordance with the Contract Documents without change in the Contract Sum or Contract Time. Prior to proceeding in accordance with these instructions, indicate your acceptance of these instructions for minor change to the Work as consistent with the Contract Documents and return a copy to the Designer. The additions, deletions, or modifications described herewith are for information only. Changes to the contract will be accomplished by Change Order or Construction Change Directive.

Description

Revised locations for Gridlines AU.1 and SC1. Location of SC1 in attached sketch (A SK 012) corresponds with RFI 073 response.

Attachments:

A SK 007 Gridline AU.1 A SK 012 Gridline SC1 Marguerite Supermetal JDC


#### END OF ARCHITECTURAL SUPPLEMENTAL INFORMATION

issued by designer accepted by contractor accepted by owner

Jonathan Levi Gilbane Town of Brookline

Architects

signaturesignaturesignaturenamenamenamedatedatedate

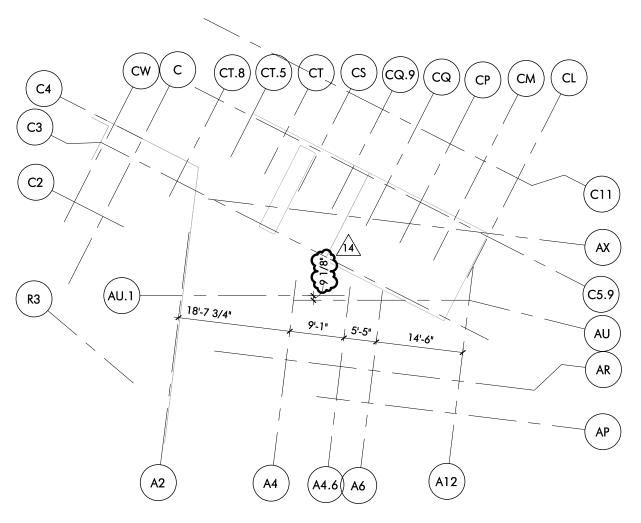

GRID LAYOUT PLAN - FLOOR 1 REF 1/A051

1/16" = 1'-0"

Project TOWN OF BROOKLINE DRISCOLL SCHOOL

Sketch Title


**GRIDLINE AU.1** 

Issued V	Vith:		
No:	Date:	Descri	ption:
14	10/22/2021	ASI 008	3
Doforon	ac Shoot, A051,	A052,	Skatah Numbar

A053, A054 Project No.: 1823 1/16" = 1'-0"

Scale:

A SK 007

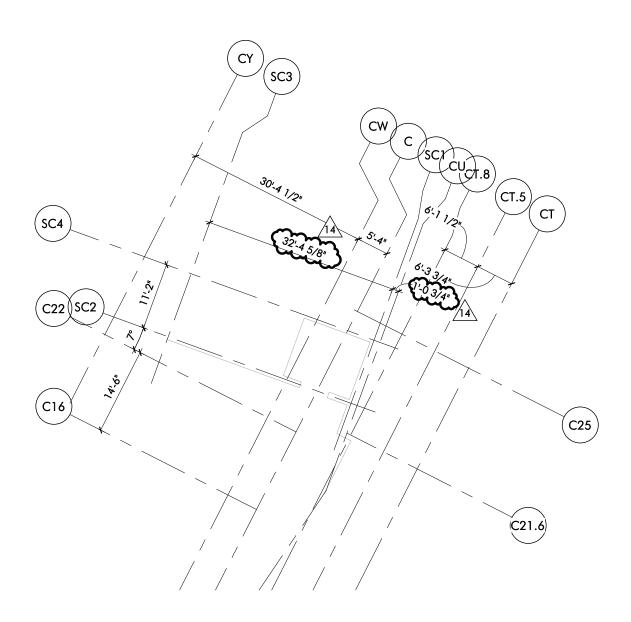

GRID LAYOUT PLAN - FLOOR 1 REF A051



TOWN OF BROOKLINE
DRISCOLL SCHOOL

 Issued With:
 No:
 Date:
 Description:

 14
 10/22/2021
 ASI 008

Sketch Title
GRIDLINE SC1

Reference Sheet: A051 Sketch Number Project No.: 1823

Scale:

1823 A SK 012

From: Ryan Little <rli>Sent: Ryan Little <rli>JDerenzo.com>
Tuesday, December 14, 2021 10:44 AM

To: Shouldice, Colleen

**Subject:** RE: MDS- ASI #8 Gridlines SC1 and AU.1

#### [EXTERNAL]

This ASI just adjusted grid lines on architectural plan, no impacts to any scope.

Thanks

From: Shouldice, Colleen < <a href="mailto:CShouldice@GilbaneCo.com">CShouldice@GilbaneCo.com</a>>

Sent: Tuesday, December 14, 2021 10:37 AM

**To:** Ryan Little < rlittle@JDerenzo.com >

Subject: RE: MDS- ASI #8 Gridlines SC1 and AU.1

Ryan,

See below, any update?

Colleen

From: Shouldice, Colleen

**Sent:** Tuesday, October 26, 2021 1:54 PM **To:** Ryan Little <a href="mailto:rlittle@jderenzo.com">rlittle@jderenzo.com</a>

Cc: Callahan, Lynda M. <LCallahan@Gilbaneco.com>; Heiberger, William <WHeiberger@GilbaneCo.com>

Subject: MDS- ASI #8 Gridlines SC1 and AU.1

Ryan,

See attached RFQ for ASI #8 Gridlines SC1 and AU.1, please review and provide pricing if needed for this ASI if applicable. Pricing is due back 11/2.

Let me know if you have any questions, Colleen

Colleen Shouldice Project Engineer 802-282-1010 **Gilbane Building Company** cshouldice@gilbaneco.com From: David Stempler <a href="mailto:dstempler@margueriteconcreteinc.com">dstempler@margueriteconcreteinc.com</a>

Sent: Tuesday, December 14, 2021 11:07 AM

**To:** Shouldice, Colleen

Subject: RE: MDS- ASI #8 Gridlines SC1 and AU.1

#### [EXTERNAL]

No additional cost for us.

**David Stempler | Project Manager** 



239 South Street Hopkinton, MA 01748

t. (508) 341-3878

www.margueriteconcreteinc.com

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From: Shouldice, Colleen < <a href="mailto:CShouldice@GilbaneCo.com">CShouldice@GilbaneCo.com</a>>

Sent: Tuesday, December 14, 2021 10:35 AM

To: David Stempler < dstempler@margueriteconcreteinc.com >

Subject: RE: MDS- ASI #8 Gridlines SC1 and AU.1

Dave,

Any update?

Colleen

From: Shouldice, Colleen

Sent: Tuesday, October 26, 2021 2:04 PM

To: David Stempler <dstempler@margueriteconcreteinc.com>

Cc: Callahan, Lynda M. <LCallahan@Gilbaneco.com>; Heiberger, William <WHeiberger@GilbaneCo.com>

Subject: MDS- ASI #8 Gridlines SC1 and AU.1

Dave,

See attached RFQ for ASI #8 Gridlines SC1 and AU.1, please review and provide pricing if needed for this ASI if applicable. Pricing is due back 11/2.

Let me know if you have any questions, Colleen

Colleen Shouldice Project Engineer 802-282-1010

Gilbane Building Company

cshouldice@gilbaneco.com

From: Jeff Ray <jray@salemglass.com>
Sent: Tuesday, October 26, 2021 3:49 PM

**To:** Shouldice, Colleen

Cc: Heiberger, William; Callahan, Lynda M.
Subject: RE: MDS- ASI #8 Gridlines SC1 and AU.1

Attachments: RFQ- ASI #8 Gridlines SC1 and AU.1- Salem Glass.pdf

#### [EXTERNAL]

Colleen

No price effect on Salem Glass, see attached.

Thank you

Jeff R Ray Project Manager **Salem Glass Company** 3 Technology Way Salem, MA 01970

Cell: 978.998-1833 Fax: 978.745.4036

Email: jray@salemglass.com Web: www.salemglass.com

From: Shouldice, Colleen [mailto:CShouldice@GilbaneCo.com]

Sent: Tuesday, October 26, 2021 3:01 PM

To: Jeff Ray

Cc: Heiberger, William; Callahan, Lynda M.

Subject: RE: MDS- ASI #8 Gridlines SC1 and AU.1

**[EXTERNAL EMAIL]** DO NOT CLICK links or attachments unless you recognize the sender and know the content is safe.

Jeff,

I apologize, see attached updated ASI #8 with correct ASI backup.

Colleen

From: Jeff Ray <<u>jray@salemglass.com</u>>
Sent: Tuesday, October 26, 2021 2:46 PM

To: Shouldice, Colleen < <a href="mailto:CShouldice@GilbaneCo.com">CShouldice@GilbaneCo.com</a>>

Cc: Heiberger, William <WHeiberger@GilbaneCo.com>; Callahan, Lynda M. <LCallahan@Gilbaneco.com> Subject: RE: MDS- ASI #8 Gridlines SC1 and AU.1

#### [EXTERNAL]

#### Colleen

Is this a test?? What's the difference between ASI #7 and ASI #8??

I'm looking at the drawings and they are both dated and marked ASI #7 mock up, i don't see gridlines SC1 and AU.1.

Am i missing something??

Please let me know but ASI #7 was no cost change, so ASI #8??

Thank you

Jeff R Ray

Project Manager

**Salem Glass Company** 

3 Technology Way Salem, MA 01970

Cell: 978.998-1833 Fax: 978.745.4036

Email: jray@salemglass.com Web: www.salemglass.com

From: Shouldice, Colleen [mailto:CShouldice@GilbaneCo.com]

**Sent:** Tuesday, October 26, 2021 2:06 PM

To: Jeff Ray

Cc: Heiberger, William; Callahan, Lynda M. **Subject:** MDS- ASI #8 Gridlines SC1 and AU.1

[EXTERNAL EMAIL] DO NOT CLICK links or attachments unless you recognize the sender and know the content is safe.

Jeff,

See attached RFQ for ASI #8 Gridlines SC1 and AU.1, please review and provide pricing if needed for this ASI if applicable. Pricing is due back 11/2.

Let me know if you have any questions, Colleen

Colleen Shouldice Project Engineer 802-282-1010

**Gilbane Building Company** 

cshouldice@gilbaneco.com

From: Jean-Francois Leclerc < jeanfrancois.leclerc@supermetal.com>

Sent: Tuesday, December 14, 2021 9:30 AM

To: Callahan, Lynda M.

Cc: Shouldice, Colleen; Heiberger, William

Subject: RE: Michael Driscoll School - Pricing Status

#### [EXTERNAL]

Good morning Lynda,

Here is a brief summary.

ASI-7 is no cost.

#### ASI-8 is no cost.

ASI-10 is no cost.

PR-003 will be a credit.

ASI-11 and ASI-12: I will review and price next week.

ASI-2 price has been submitted in July and pending issuance of change order



Jean-Francois Leclerc, ing. / Eng.

Vice-Président Administration de Contrat / Vice-President Contract Administration Supermetal Structures inc.
1955, 5e Rue
Lévis, QC
Canada, G6W 5M6

Tél.: 418-834-1955 #2340 Fax.: 418-834-5151

Visit our Web Site / Visitez notre site web: www.supermetal.com

De: Callahan, Lynda M. < LCallahan@Gilbaneco.com >

Envoyé: 14 décembre 2021 06:41

À: Jean-Francois Leclerc < jeanfrancois.leclerc@supermetal.com>

Cc: Shouldice, Colleen < <a href="mailto:CShouldice@GilbaneCo.com">CShouldice@GilbaneCo.com</a>; Heiberger, William

<WHeiberger@GilbaneCo.com>

**Objet:** Michael Driscoll School - Pricing Status

Importance: Haute

Good Morning JF

Could you please provide status update on pricing for the listed changes. Please let me know if you have any questions or comments. Thank you.

PCI No	Phase Code	PCI	SCO#	Quoted	Final	PCI Orig	Sent
Description	Description	Line Sts.				Date	Date
Vendor: SUPST003 - Supermetal Struc	tures Inc., Contract: J08864.000-0006						
OS-00004	01.05A.060000.I	POT				06/08/21	12/10/21
ASI #11R Roof Edge Blocking Revisions	Structural Steel						
OS-00025	01.05A.060000.I	POT				10/13/21	
ASI #7 Mock Up Angled Window	Structural Steel						
OS-00026	01.05A.060000.I	POT				10/25/21	10/26/21
PROO3 & PROO3R Geothermal	Structural Steel						
OS-00027	01.05A.060000.I	POT				10/26/21	
ASI #8 Gridlines SC1 and AU.1	Structural Steel						
OS-00035	01.05A.060000.I	POT				11/16/21	
ASI #10 Shaft Transitions at Ceilings,	Structural Steel						
OS-00038	01.05A.060000.I	POT				11/26/21	11/26/21
ASI #12 Elevator Structure	Structural Steel						

#### Lynda

Lynda Callahan | Sr. Project Manager | Gilbane Building Company

10 Channel Center St | Boston, MA | 02210

O: (617)960-2956 | M: (617)320-5153 | F: (617)478-3001

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Building More than Buildings® for more than 140 Years
Gilbane, a three-time member of Fortune's "100 Best Places to Work" list and a thirteen-time member of *Training Magazine's* Top 125

#### Gilbane Building Company **Authorization To Proceed**



CONTRACT FOR: Brookline - Driscoll School

OWNER: Town of Brookline ADDRESS: 333 Washington Street

Brookline, MA, 02445

PROJECT NUMBER: ATP NO: ATP VERSION:

DATE OF ISSUANCE: SUBMITTED BY:

12/07/2021 Gilbane Building Company

J08864.000

ATP-0023

**ALTERNATE** TRACKING #:

ARCHITECT: Jonathan Levi Architects LLC, Mark Warner

The Contract Documents are hereby amended to include the additional Work described below, which is outside of the current scope of the Work and constitutes a change.

Upon Owner approval, Gilbane Building Company will proceed with the Work promptly.

Costs as incurred are in addition to the current contract Sum and will be invoiced and paid on a monthly basis and identified as separate items within the requisition. Once final cost of the Work involved and change in Sum and Time (if any) are fully determined, it will be submitted for inclusion in a final Change Order adjusting the Contract Sum and/or Time.

TITLE: RFI #160 Washington Street Sanitary Sewer Connection

DESCRIPTION: Per RFI #160 replacing SMH2 doghouse/drop over sanitary sewer manhole on Washington Street with pipe to pipe connection utilizing a tee coupling. City of Brookline prefers this method.

#### Attachments:

Number	Description:	PCI Number	Change Date	Revision
00205382	ATP-23 Backup	OS-00040	12/07/2021	Original Version

The Following information is provided by Gilbane Building Company

Method of determining change in Contract:

	Cost Plus Fee	<b>□</b> Unit Price	Lump Sum
Other			

Change In Contract Sum Dollar Amount: -\$4,052.00

■ Estimated Fixed ■ Maximum Time and Material

> Change In Contract Time Time (Days): TBD

Fixed 

Job	PCI No.	Description	Phase Code	SubContractor	Amount	Accept?
J08864.000	OS-00040	Sitework		J. Derenzo Company	-\$4,052.00	C Yes C No
TOTAL FOR PCI No.	OS-00040	(\$4,052.00)				

**Submitted Amt:** -\$4,052.00

Gilbane Building	Company
------------------	---------

#### Gilbane Building Company

Signed: 12/10/2021 7:13:41 AM Eastern Standard Time - By: Lynda Callahan (Senior Project Manager )

Gilbane Building Company: 10.20.1.124

onathan Levi Architects LLC

By: Carof Harris

Proejct Manager here

company: Jonathan Levi Architects

Date: 121321

Printed Name: Carol Harris

.EFTFIELD, LLC

By: Lynn Stapleton

Title: OPM

Company: LeftField Project Management

Date: 12/16/21

Printed Name: Lynn Stapleton

own of Brookline

REVIEWED

By:

Title:

Company: T.O.B.

Date: 16 DECEMBER 2021

Printed Name: ANTHONY GUIGE

338 HOWARD ST. I BROCKTON, MA I 02302

November 23, 2021

#### Gilbane Building Company

10 Channel Center St. Boston, MA 02210

Attn: Lynda Callahan, Sr. Project Manager
Project: Michael Driscoll School – Brookline, MA

Re: JDC PCO 005 – Credit Furnish & Install of SMH2

Lynda,

J. Derenzo Co. proposes to perform the scope detailed herein, based on the stated qualifications, inclusions, and exclusions, for a credit price of \$ (4,052.00)

A detailed breakdown of change in scope referenced in this cover sheet is enclosed.

#### **Qualifications:**

- Change documented in JDC RFI 007/GBCO RFI 160
  - Replace SMH2 doghouse/drop over sanitary sewer manhole in Washington St. with a pipeto-pipe connection utilizing an inserta tee coupling
  - o Change proposed by City of Brookline who prefers this approach

#### **Inclusions:**

- Credit for material price to furnish SMH2
- Credit for install/setting of precast structure
- Add for material price to furnish inserta tee connection, extra pipe, fittings
- Add for install of inserta tee connection

#### **Exclusions:**

- Add/Credit for excavation/shoring/backfill
  - o Unchanged from contract scope of work

If you have any questions concerning this proposal, please do not hesitate to contact me using the information listed below.

Respectfully, J. DERENZO CO.

Ryan Little

Project Manager 508-649-9702

rlittle@jderenzo.com

# **Proposal**

From:

J Derenzo Co

338 Howard Street

Brockton, MA 02302 USA

Brockton, MA 02302 USA Phone: (508) 427-6441		Description:	CREDIT FOR DELETION OF SMH2	
ITEM / DESCRIPTION	BID QTY	U/M	UNIT BID	AMOUNT
001 CREDIT FURNISH & INSTALL OF SMH2	-1.000	EA	\$7,219.52 *	\$-7,219.52
002 FURNISH & INSTALL OF SEWER CONNECTION	1.000	EA	\$3,167.12 *	\$3,167.12
* CAUTION!!! The total bid shown may not be correct becand physically type Bid Units for all items with an * next to		orrect rounding, re	TOTAL BID: turn to the bid sheet	\$-4,052.40
Signature:	the blu Offit value.			

Project:

DRISCOLL SCHOOL - PCO 005 -

CREDIT F&I SMH2

PROJECT: DRISCOLL SCHOOL - PCO

Item:

# ITEM SHEET COSTS

AS SHOWN Unit of Measure: EΑ

Date: 11/23/2021 10:31:32AM

CREDIT FURNISH & INSTALL OF SMH2 Description: Bid Quantity:

-1.00 Cost Code: Take-off Quantity: -1.000

Production: DAYS Total Man-Hours: -24.00 24.0000 Hours per Day: 8 Man-Hours per Unit:

Alternate: Units / MH: 0.0417

#### **Item Production**

ITEM#	DESCRIPTION	U/M	QTY	Time Units	Time Req'd
001	CREDIT FURNISH & INSTALL OF SMH2	EA	-1.00	1.00 (D)	-1.00

	Cost Detail for Item 001							
R	Code	Description		QTY	U/M	Factor	Rate	Cost
L	JDC-FOR	FOREMAN -	94.52/hr	1.00		-1.00	756.16	-756.16
L	JDC-LAB	LABORER <	93.76/hr	2.00		-1.00	750.08	-1,500.16
Ε	RTE-001	CAT M322 RTE W/ OP	←—401.72/hr	1.00		-1.00	3,213.76	-3,213.76
Z	Z							
М	WRITEIN	SMH2 DOGHOUSE MH		-1.00	EA	1.00	1,048.29	-1,048.29
M	WRITEIN	SMH F/C		-1.00	EA	1.00	701.15	-701.15
		Item Unit Cost:	7,219.52			Item Total C	Cost:	-7,219.52

	Labor	Equipment	Rental Eq	Material	Subcontract	Other
Total:	-2,256.32	-3,213.76	0.00	-1,749.44	0.00	0.00
Unit:	2,256.32	3,213.76	0.00	1,749.44	0.00	0.00

Bid Data for Item: 001						
	Quantity	Bid Unit	Bid Amount	Total Cost	Prof & Ovhd	Windfall
Bid Qty:	-1.00	7,219.52	-7,219.52	-7,219.52	0.00	
Take-off Qty:	-1.00	7,219.52	-7,219.52	-7,219.52	0.00	0.00

PROJECT: DRISCOLL SCHOOL - PCO

## ITEM SHEET COSTS AS SHOWN

Date: 11/23/2021 10:31:32AM

Item: Unit of Measure: EΑ

FURNISH & INSTALL OF SEWER CONNECTION Bid Quantity: Description: 1.00

Cost Code: Take-off Quantity: 1.000 Production: DAYS Total Man-Hours: 12.00 8 12.0000 Hours per Day: Man-Hours per Unit:

0.0833 Alternate: Units / MH:

#### **Item Production**

ITEM#	DESCRIPTION	U/M	QTY	Time Units	Time Req'd
002	FURNISH & INSTALL OF SEWER CONNECTIO	EA	1.00	2.00 (D)	0.50

	Cost Detail for Item 002						
R	Code	Description	QTY	U/M	Factor	Rate	Cost
L	JDC-FOR	FOREMAN — 94.52/hr	1.00		0.50	756.16	378.08
L	JDC-LAB	LABORER 93.76/hr	2.00		0.50	750.08	750.08
Ε	RTE-001	CAT M322 RTE W/ OP $\leftarrow$ 401.72/hr	1.00		0.50	3,213.76	1,606.88
Z	Z						
М	WRITEIN	8" INSERTA TEE	1.00	EA	1.00	200.00	200.00
М	WRITEIN	8" PVC SDR35	14.00	LF	1.00	8.72	122.08
М	WRITEIN	8" PVC SDR35 BENDS	2.00	EA	1.00	55.00	110.00
		Item Unit Cost: 3,167.12			Item Total C	ost:	3,167.12

	Labor	Equipment	Rental Eq	Material	Subcontract	Other
Total:	1,128.16	1,606.88	0.00	432.08	0.00	0.00
Unit:	1,128.16	1,606.88	0.00	432.08	0.00	0.00

Bid Data for Item: 002							
	Quantity	Bid Unit	Bid Amount	Total Cost	Prof & Ovhd	Windfall	
Bid Qty:	1.00	3,167.12	3,167.12	3,167.12	0.00		
Take-off Qty:	1.00	3,167.12	3,167.12	3,167.12	0.00	0.00	


# REQUEST FOR INFORMATION

RFI No.: JDC-007



PROJECT: ADDRESS:	M. Driscoll School 64 Westbourne Terrace	DATE: <u>11/19/21</u>
	Brookline, MA 02446	-
PROJECT No.:	JDC 21018	-
SUBMITTED B Ryan Little J. DERENZO C 338 HOWARD S BROCKTON, N	OMPANY ST	SUBMITTED TO: Lynda Callahan Gilbane 10 Channel Center St., S100 Boston, MA 02210
REQUEST:	the City of PropUline they would prefer a pine t	
		to pipe connection in lieu of the doghouse manhole in Washington St.
	t to the project to furnish and install/set the stru	cture, no credit for excavation/snoring/etc.
Please confirm this app	oroach is acceptable.	
SUGGESTION:		
Existing 12" PVC would	I be cored and connected to with an 8" inserta-	tee (product data attached herein).
RESPONSE:		
ATTACHMENT	S: YES NO	
ATTAOTIMENT	J 120 110	

# Inserta Tee<sup>®</sup> Lateral Connection

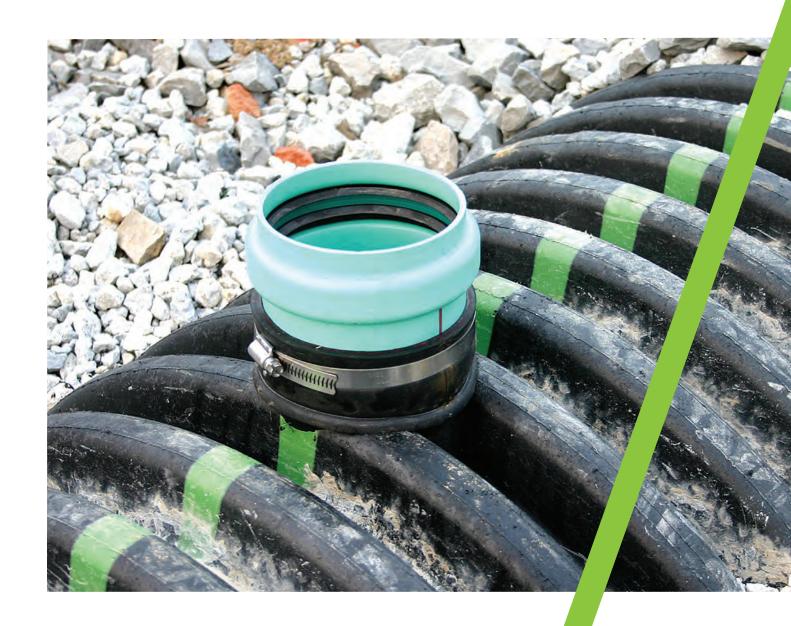



## **Inserta Tee Description**

Inserta Tee is a three-piece service connection consisting of a PVC hub, rubber sleeve and stainless steel band. Inserta Tee is compression fit into the cored wall of a mainline and requires no special tooling. Inserta Tees are designed to connect 2"-24" (51-600 mm) laterals to all known solid wall, profile, closed profile, corrugated pipe and manhole structures manufactured today.

#### Inserta Tee for new & rehab installations:

- Reduction in labor hours and pipe materials
- Services connected where needed.
- · No need to disturb backfill
- Fits all gravity flow pipe and manholes
- Matches pipe's internal radius or structure for minimal penetration

#### Inserta Tee eliminates the need for:

- · Glues, epoxies and grout
- · Re-tightening of bands around mainline
- Awkward gaskets

# When sliplining, pipe bursting and relining, Inserta Tee allows the following:

- Simple installation doesn't require special equipment
- For pipe bursting the connection is made directly into solid wall HDPE pipe

Inserta Tee construction varies with pipe type and size. For pipe not listed, contact our engineering department.

# Inserta Tee OneFit™

OneFit is an Inserta Tee with an adjustable rubber sleeve that will fit any mainline pipe.

- Same great performance
  - reliable, a fitting you can count on
- Saves time
  - fast and efficient installation
- · Saves money
  - lower material and labor costs

#### **Applications for OneFit**

- Roof drain leaders
- Structures
- Irrigation/Agriculture
- Nyloplast® drain basins
- Municipal repair/rehab
- Storm sewers
- Retention/Detention
- All pipe types
- Fiberlass manholes
- Rainwater harvesting

#### **Stainless Steel Band**







**Rubber Sleeve** 

Gasketed PVC Hub



**Inserta Tee Lateral Connection** 



**Inserta Tee OneFit** 

# **Inserta Tee Applications**

Inserta Tees can be utilitzed on a wide variety of projects, including the following:

- Storm sewers
- Sanitary sewers
- Pipe bursting (HDPE/PVC)
- Sliplinging
- Fold-and-formed products
- Cured-in-place products
- Manholes
- · Wet wells
- Drainage
- Irrigation
- Catch basins
- Electrical Vaults



**Storm Sewer** 

### **Inserta Tee Hole Saws**

#### **DIAMOND BITS**

Our diamond bits are of the highest quality to ensure maximum holes per bit. Diamond bits are recommended for concrete, clay, fiberglass and ductile iron.

#### **HOLE SAWS**

Our specially designed hole saws allow the user to core fast, smooth and clean holes.

Inserta Tee Size	Hole Saw Size
2" (51 mm)	2%" (67 mm)
3" (75 mm)	3¾" (95 mm)
4" (100 mm)	4½" (114 mm)
6" (150 mm)	6½" (165 mm)
8" (200 mm)	8¾" (222 mm)
10" (250 mm)	10%" (276 mm)
12" (300 mm)	12%" (327 mm)
15" (375 mm)	15 <sup>13</sup> / <sub>16</sub> " (402 mm)
18" (450 mm)	19 <sup>3</sup> / <sub>16</sub> " (503 mm)
21" (525 mm)	22 <sup>9</sup> / <sub>16</sub> " (573 mm)
24" (600 mm)	25 <sup>5</sup> / <sub>16</sub> " (643 mm)



**Hole Saws** 

#### **ADS Inserta Tee Product Specification**

#### Scope

This specification describes 2"-24" (50 to 600 mm) Inserta Tee service connections for use in gravity-flow sewer and drainage applications.

#### **Product Requirements**

Inserta Tee service connections shall consist of a PVC hub, rubber sleeve and stainless steel band. Connections shall be a compression fit into the cored wall of a mainline pipe. hub shall be made from heavy-duty PVC material. Stainless steel clamping assembly shall be made from minimum 301 grade steel. Rubber sleeve and gasket, when applicable, shall meet the requirements of ASTM F477. Gaskets shall be installed by the manufacturer. The water-based solution provided the manufacturer shall be used during assembly. Do NOT use pipe lube.

The Inserta Tee can be installed into any mainline pipe or structure. Connection hubs are available to connect to: corrugated polyethylene, corrugated polypropylene, PVC C900, SDR 26 HWS, SDR 35 (gasketed bell, SWR spigot & solvent weld bell), IPS/Sch40 (gasketed bell & solvent weld bell) and corrugated PVC. Custom pipe types available.

#### **Joint Performance**

Inserta Tee product includes a watertight bell connection meeting the requirements of ASTM D3212.

#### **Field Pipe and Joint Performance**

To assure watertightness, field performance verification may be accomplished by testing in accordance with ASTM F2487, ASTM C969 or ASTM F1417\*. Appropriate safety precautions must be used when field testing any pipe material. Contact the manufacturer for recommended leakage rates.

#### Installation

Installation shall be in accordance with manufacturer's recommended installation guidelines. The use of installation methods or hole saws not purchased from Inserta Fittings will void the performance warranty of the product. Backfill around the Inserta Tee service connection shall be of the same material type and compaction level as specified for the mainline pipe installation. Contact your local representative or visit the website at www.adspipe.com for a copy of the latest installation guidelines.



Visit our website at **adspipe.com** for specifications (CAD or PDF), application details and our installation video, which may also be accessed by clicking on the QR code.

Product configuration & availability subject to change without notice. Product detail may differ slightly from actual product appearance.

\*Contact your local sales representative for acceptable watertight applications. Not all applications are standard and some may require additional technical assistance.







## **INSERTA TEE COMPARISON GUIDE**

This guide was designed to illustrate differences between INSERTA TEE and other products. It soon becomes obvious that this is truly a case of apples vs. oranges.

INSERTA TEEs are for new, rehabilitation, and repair installations and provide:

- Reduction in labor hours and pipe materials
- · Services connected where needed
- Watertight\*, testable connection every time
- Eliminates glues, epoxies, grout, tightening and retightening of bands









**Rubber Saddle Tee** 



Saddle




Other Product


Testing	tı a tı
Installation	V II v p n ii to b
Mainline Adaptibility	✓ V


Lateral Connection

Air testable in most pipes; meets the testing requirements of ASTM D3212 at 10.8 psi (75 kPa). Field testable to ASTM F2487, C969, and F1417.	Test information limited and does not meet ASTM D3212 at 10.8 psi (75 kPa).	Test information limited and does not meet ASTM D3212 at 10.8 psi (75 kPa).	Test information limited and does not meet ASTM D3212 at 10.8 psi (75 kPa).
installation instructions included with every tee to ensure coring the perfect hole. Minimum protrusion will not interfere with post-installation inspection. No straps or bands to re-tighten. No need to disturb backfill around the host pipe. Fast, effective, and easy to install.	No installation instructions on how to core the hole. Bands need to be installed around the host pipe and need to be re-tightened after 15 minutes. Backfill must be removed completely around the host pipe. Cannot be used on corrugated or ribbed host pipe.	Specific diameter hole required to keep boot from collapsing into the host pipe. Bands and straps must be tightened to specific torque and re-tightened after 15 minutes. Backfill must be removed completely around the host pipe. Cannot be used on corrugated or ribbed host pipe.	No installation instructions on how to cut the hole. Protrusion into mainline will interfere with post-installation video equipment or mandrels.
Will fit ALL common types and diameters of mainline pipe.	Limited to smooth exterior wall mainline pipe types.	Limited to smooth exterior wall mainline pipe types.	Limited mainline pipe types and diameters.
Will fit ALL common types of lateral pipe from 2"-30" (50-750 mm) diameters	Limited lateral sizes and types.	Limited lateral sizes and types.	Limited lateral sizes and types.

<sup>\*</sup>Contact your local sales representative for acceptable watertight applications. Not all applications are standard and some may require additional technical assistance.

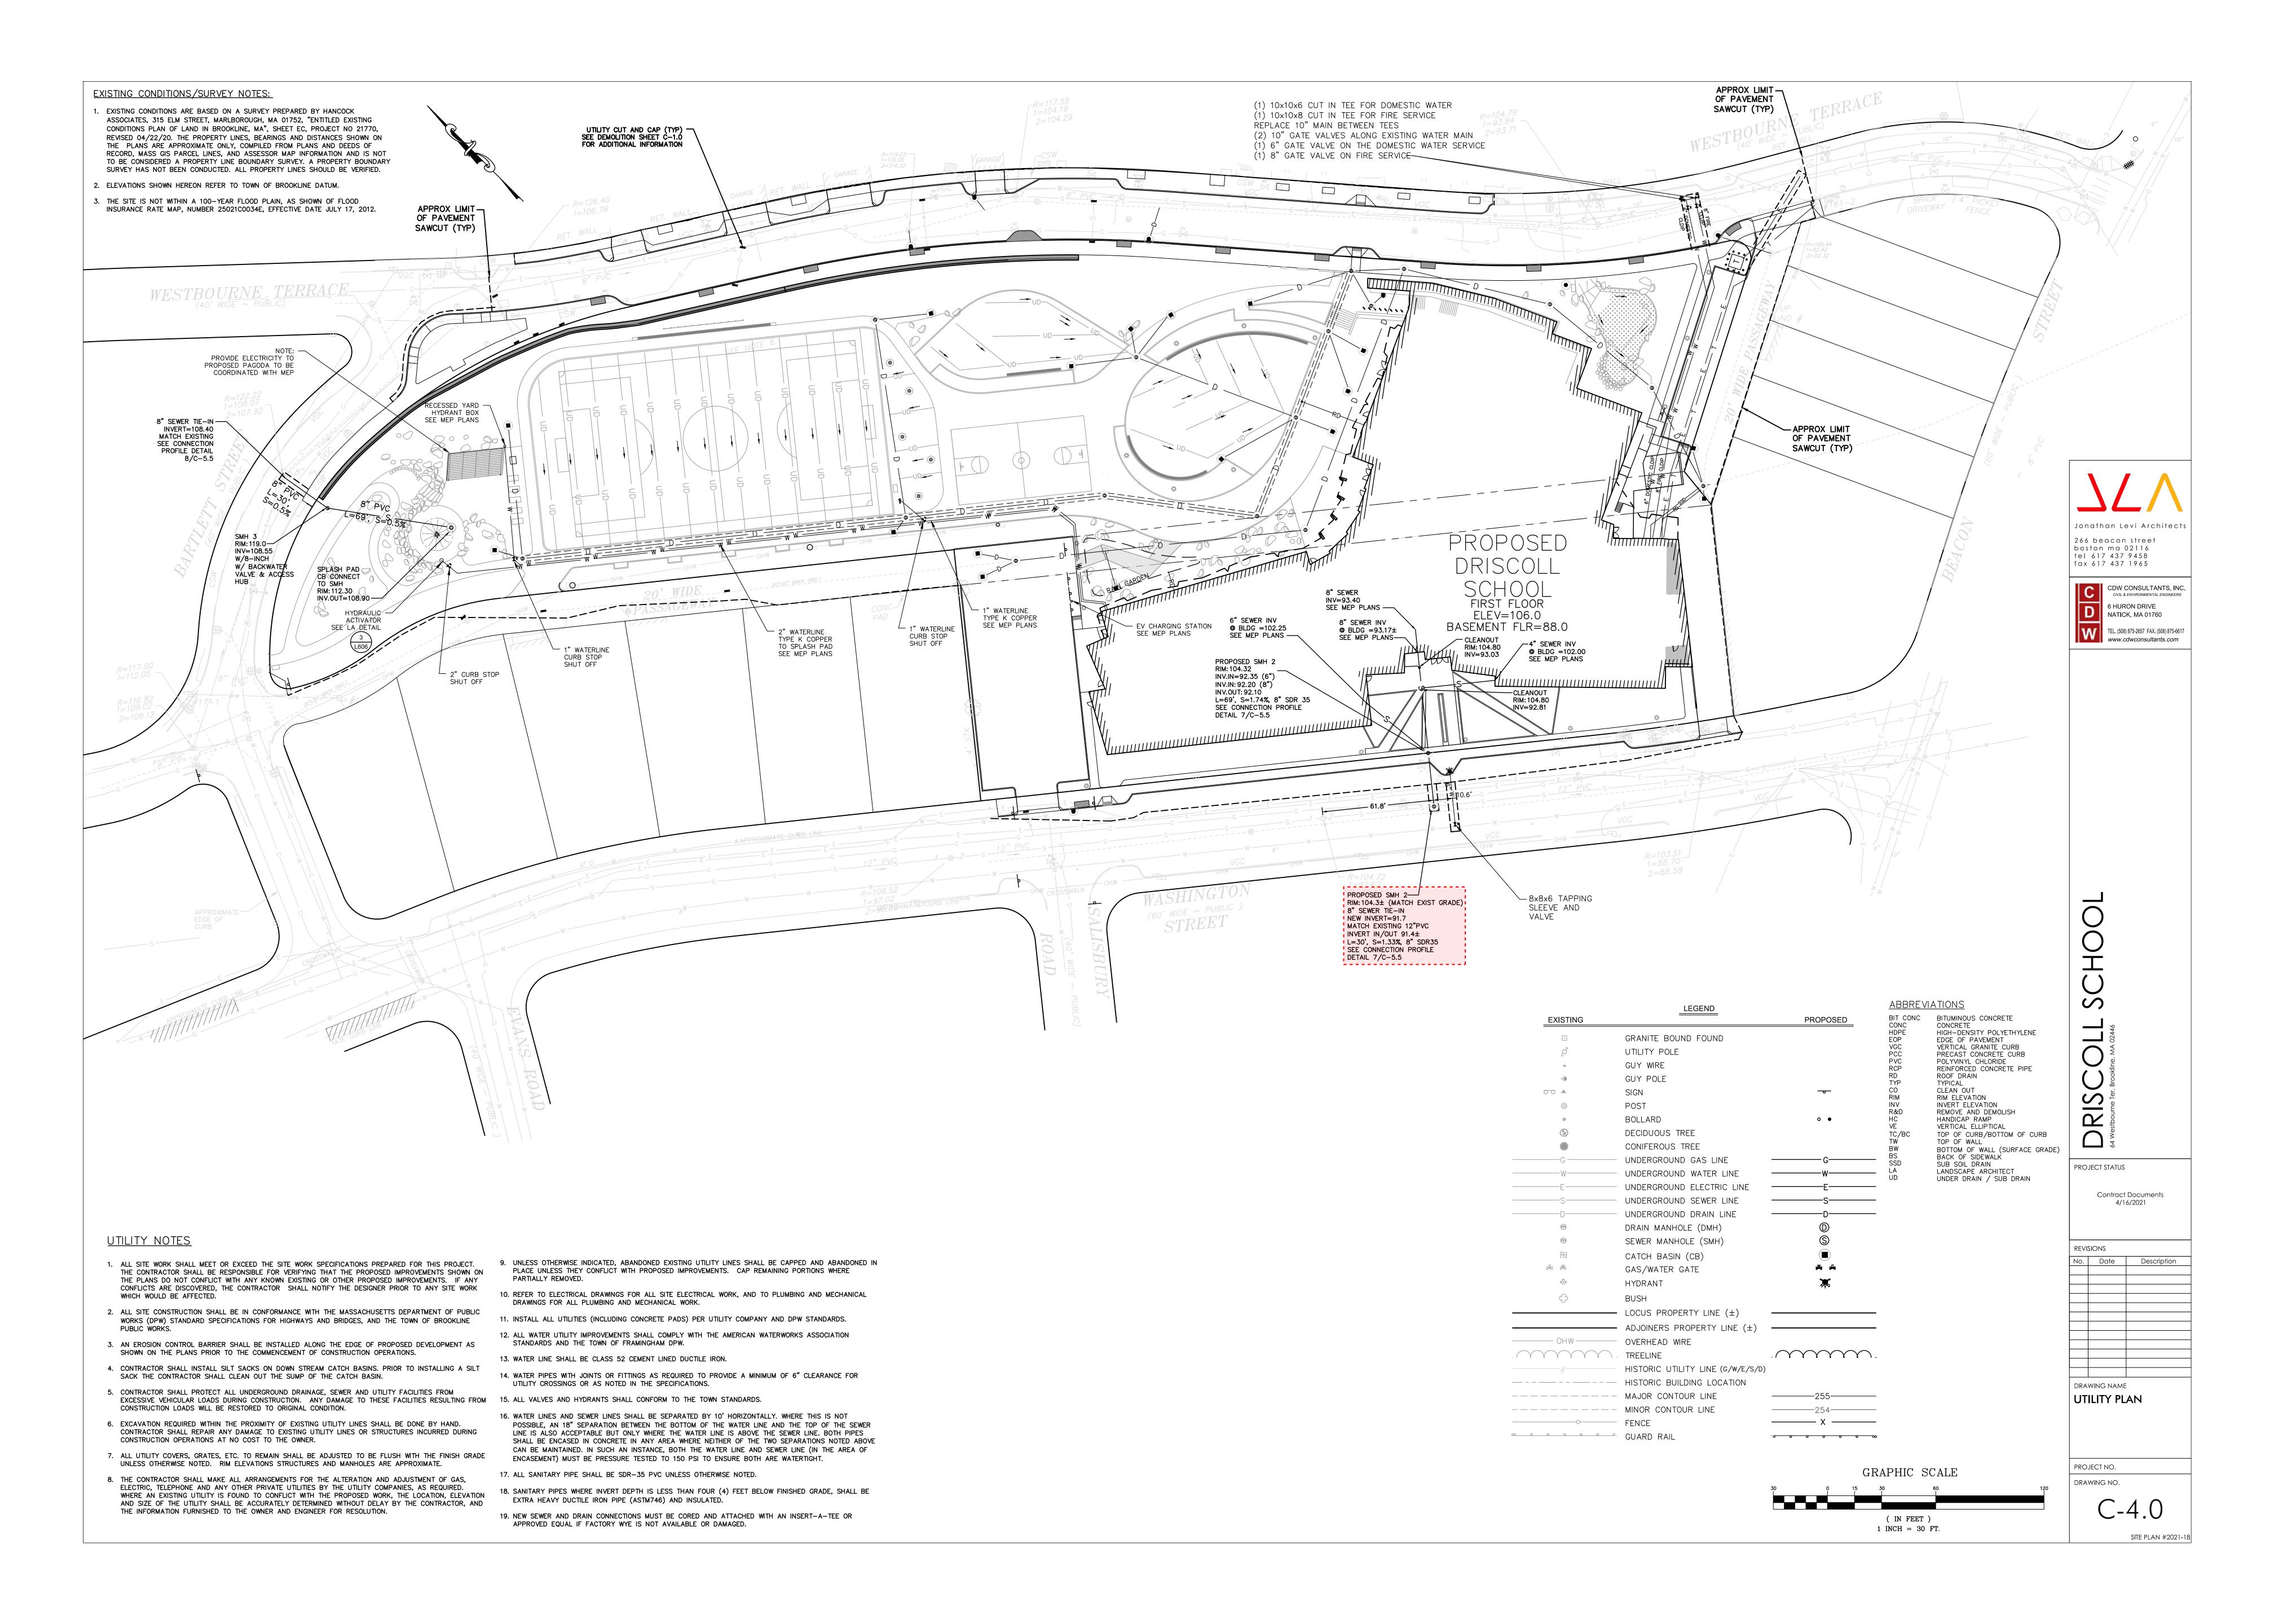

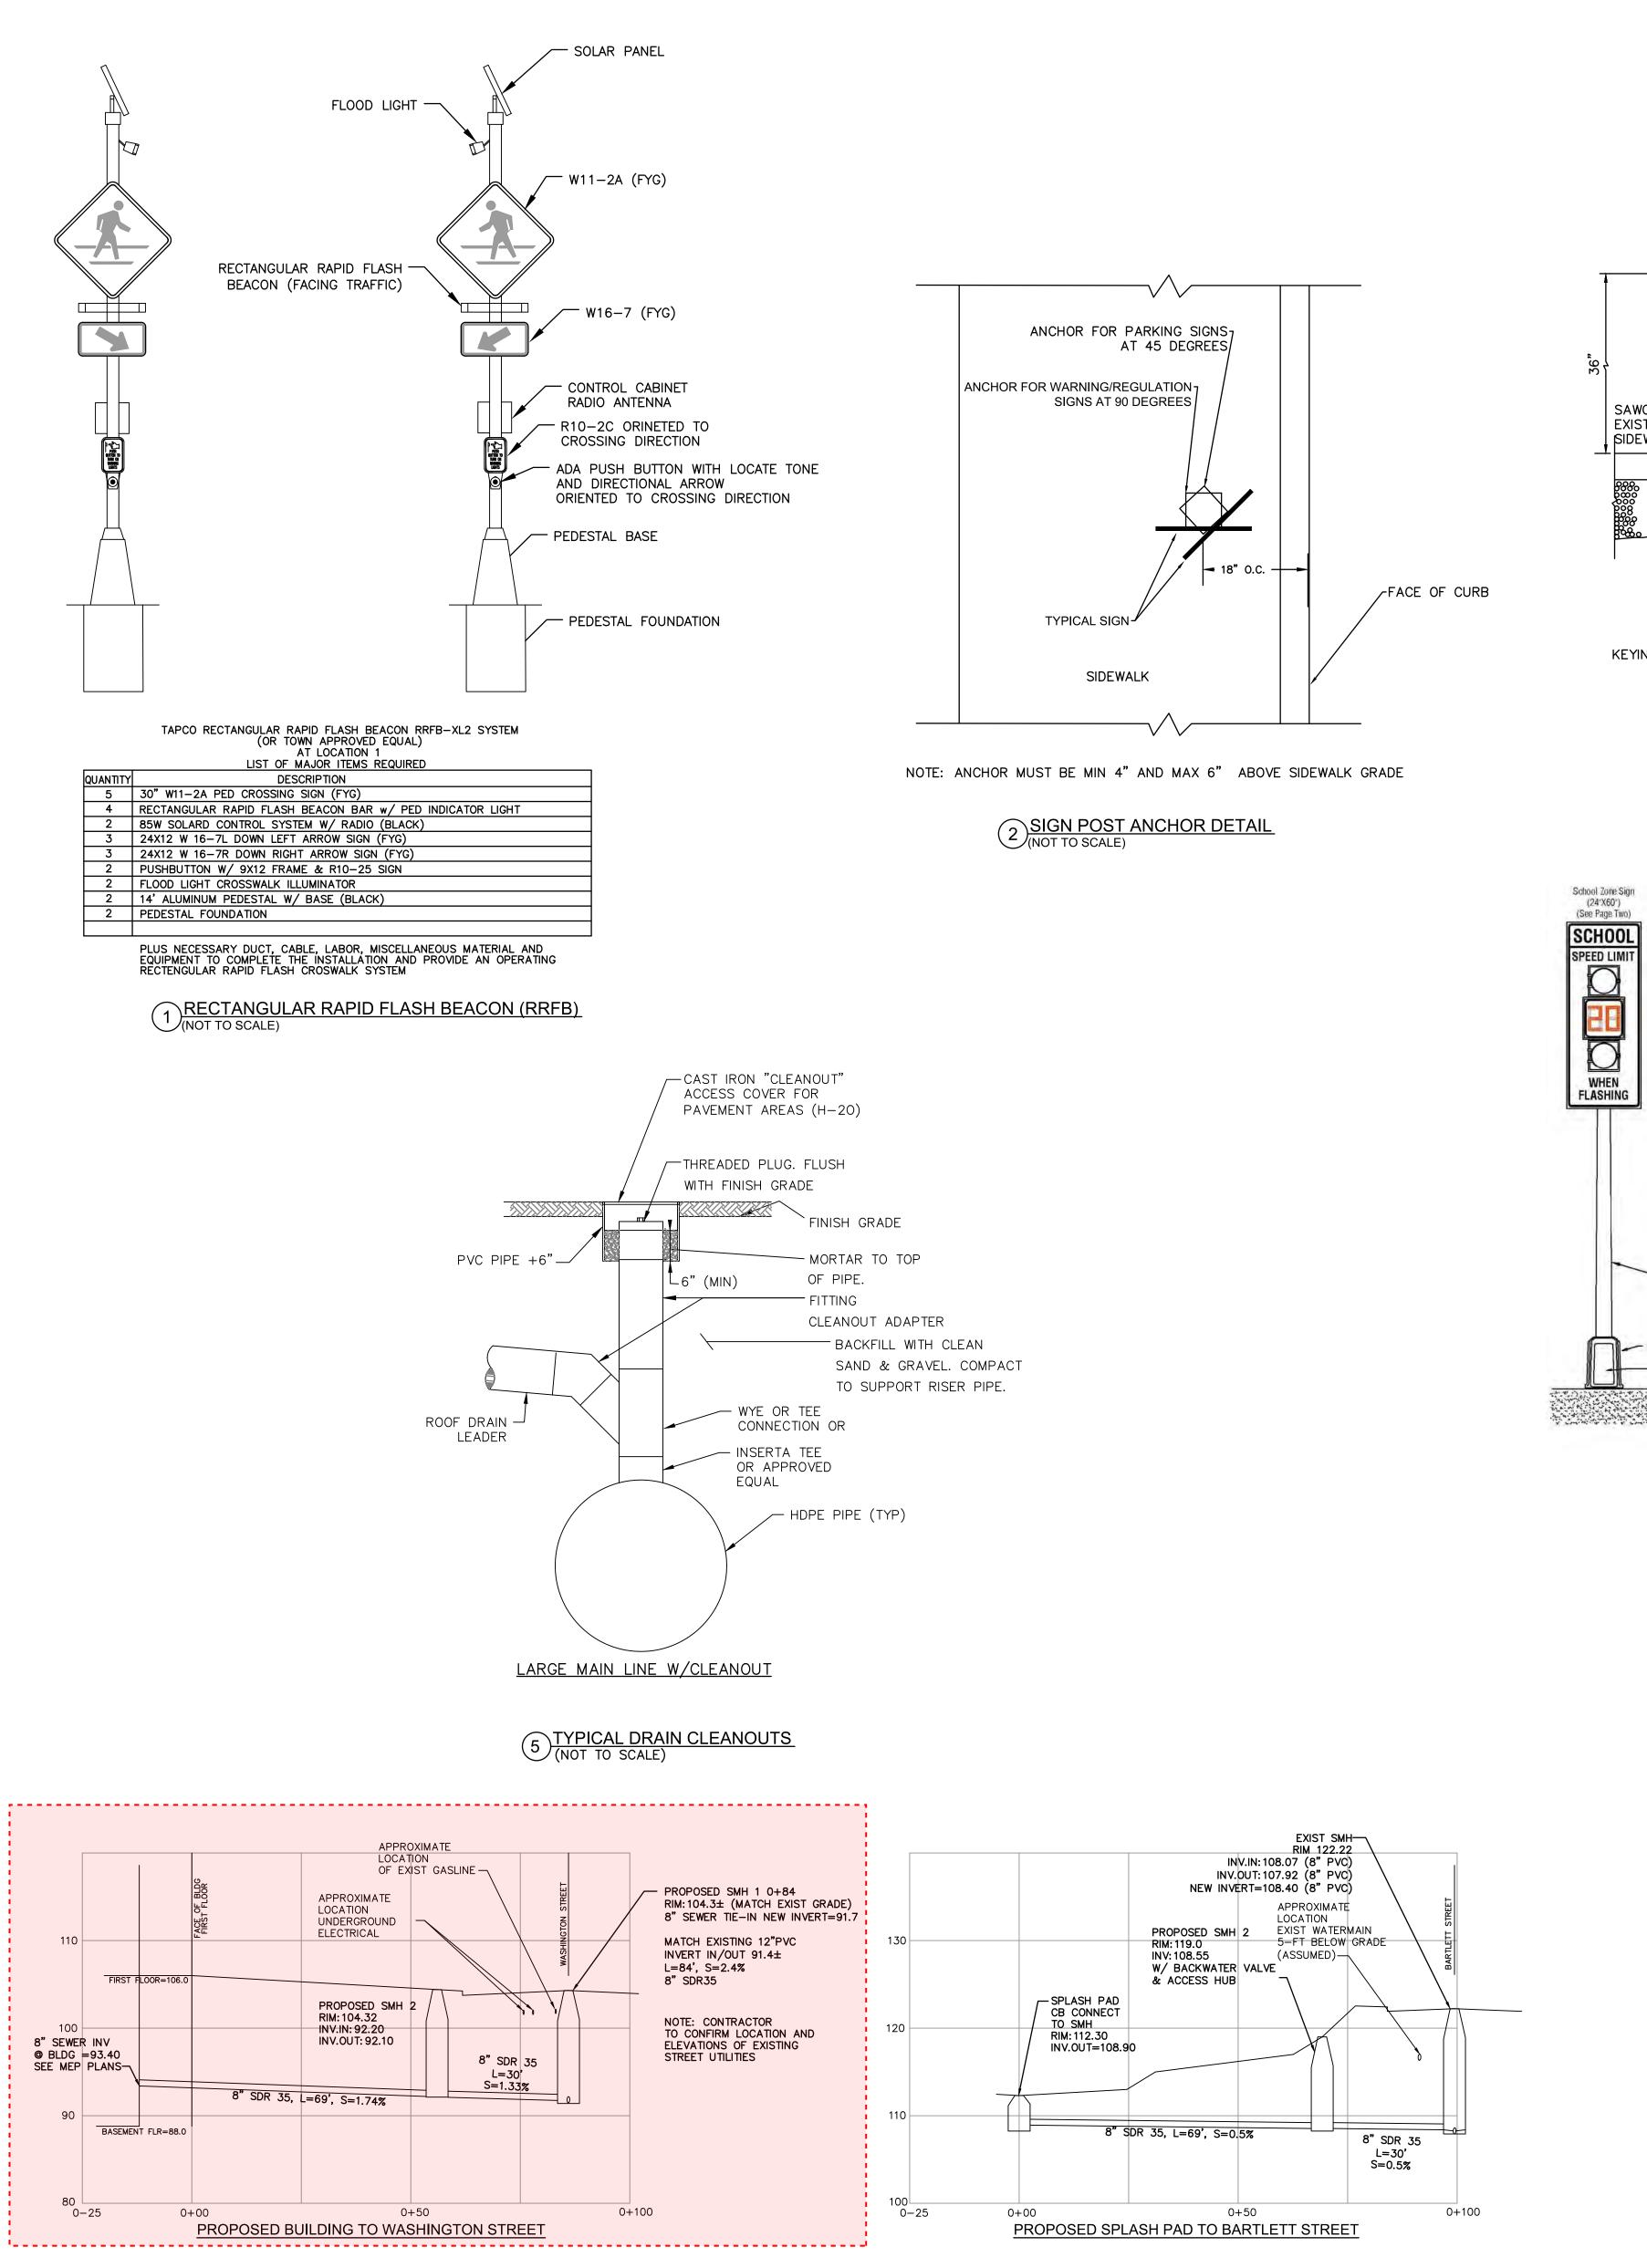

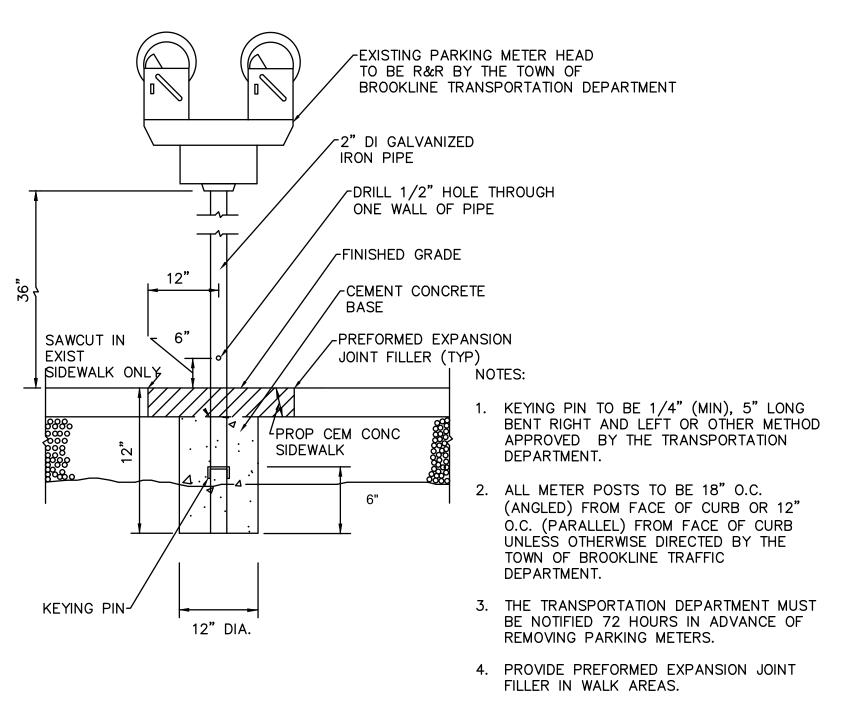

3 PARKING MEET POST DETAIL (NOT TO SCALE)

8" AMBER LED

8 Pedestal Pole


Galvinized Steel Anchor Bolts 3/4°0x2'-1" Long With 3" - 90" Hook And 4" Threaded End

DIRECTION OF TRAVEL

WHITE BIKE BUFFER DETAIL (NOT TO SCALE)

24" x 60" Retroreflective School Zone Signal Sign

SCHOOL

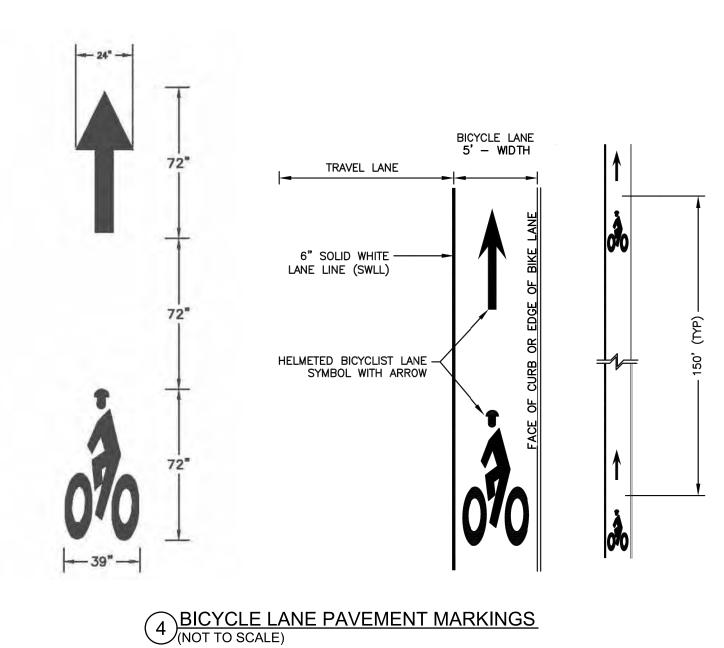

Dual Circuit Flasher

8" Signal Housing w/8" Yellow LED

12" Ped Housing w/"20" MPH LED & AP21T Time Switch

8" Signal Housing wi8" Yellow LED

SE-3310 1-Way Off-Set Post Top Assy



















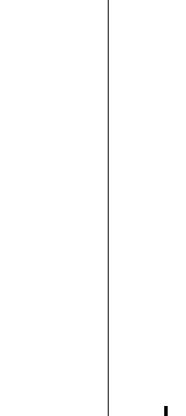

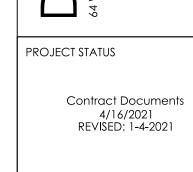

REVISI	ONS	
No.	Date	Description
	VING NAME	

CONSTRUCTION DETAILS

PROJECT NO. DRAWING NO.

C-5.5

SITE PLAN #2021-18



Gilbane Building Company 10 Channel Center Street Suite 100

Boston, Massachusetts 02210 Phone: (617) 478-2981 Project: J08864.000 - Michael Driscoll School - Brookline 64 Westbourne Terrace Brookline, Massachusetts 02446

Ryan Little (J. Derenzo Company)

33 31 00 - SANITARY UTILITY SEWERAGE

Closed on 11/23/21

11/27/2021

**PIPING** 

# JDC RFI 007 - Washington St. Sanitary Sewer Connection

FROM:

STATUS:

**DUE DATE:** 

COST CODE:

SPEC SECTION:

REFERENCE:

SCHEDULE IMPACT: No

TO: Eric Wilhelmsen (CDW Consultants, Inc.)

Juho Lee (Jonathan Levi Architects LLC)
Mark Warner (Jonathan Levi Architects LLC)
James Machek (Jonathan Levi Architects LLC)

Carol Harris (Jonathan Levi Architects LLC)

**DATE INITIATED:** 11/22/2021

**LOCATION**: FLOOR 0

PROJECT STAGE: Pre-Construction

SUB JOB:

COST IMPACT: TBD

DRAWING NUMBER: C-4.0

LINKED DRAWINGS: C-4.0, C-5.5

RECEIVED FROM: Ryan Little (J. Derenzo Company)

COPIES TO:

Robert Braga (Gilbane Building Company), Lynda Callahan (Gilbane Building Company), Colleen Shouldice (Gilbane Building Company), William Heiberger (Gilbane Building Company), Julio pinhancos (J. Derenzo Company), Derek Ullman (Gilbane Building Company)

Question from Ryan Little (J. Derenzo Company) at 04:00 PM on 11/19/2021	
See RFI attached concerning the sanitary sewer connection to the existing main in Washington St.	
Attachments:  JDC RFI 007 - Washington St. Sanitary Sewer Connection.pdf	
Official Response: Carol Harris (Jonathan Levi Architects LLC) responded on Monday, November 22nd, 2021 at 6:51PM EST CDW has no issue with the proposed connection. Provide credit.	
Attachments:	

#### All Replies:

Response from Carol Harris (Jonathan Levi Architects LLC) at 06:51 PM on 11/22/2021
CDW has no issue with the proposed connection. Provide credit.
Attachments:

If the information provided in the response to this RFI constitutes a change in contract price or time, the trade contractor shall not proceed with this work unless authorized to do so by the Construction Manager in writing. The trade contractor shall provide the Construction Manager written notice within five (5) working days from receipt of this Request for Information that this RFI constitutes a change, all in accordance with Article 8 of the Contract Agreement. Should no change be required, a no cost change will be issued to you incorporating this RFI into your contract.

ВҮ	DATE	COPIES TO


# REQUEST FOR INFORMATION

RFI No.: JDC-007



PROJECT:	M. Driscoll School	<b>DATE</b> : 11/19/21			
ADDRESS:	64 Westbourne Terrace	•			
	Brookline, MA 02446				
PROJECT No.:	JDC 21018	<u>.                                    </u>			
SUBMITTED B	Y:	SUBMITTED TO:			
Ryan Little		Lynda Callahan			
J. DERENZO C 338 HOWARD		Gilbane			
BROCKTON, M	_	10 Channel Center St., S100 Boston, MA 02210			
	_	1 BOSIOII, IVIA 02210			
REQUEST:					
Per conversations with	the City of Brookline, they would prefer a pipe to	o pipe connection in lieu of the doghouse manhole in Washington St.			
There would be a credit	to the project to furnish and install/set the struc	cture, no credit for excavation/shoring/etc.			
Please confirm this app	roach is acceptable.				
SUGGESTION:					
	— I be cored and connected to with an 8" inserta-t	ee (product data attached herein).			
RESPONSE:					
ATTACHMENT	S: NO				
- THE THE PARTY OF	J 120 110				

# Inserta Tee<sup>®</sup> Lateral Connection

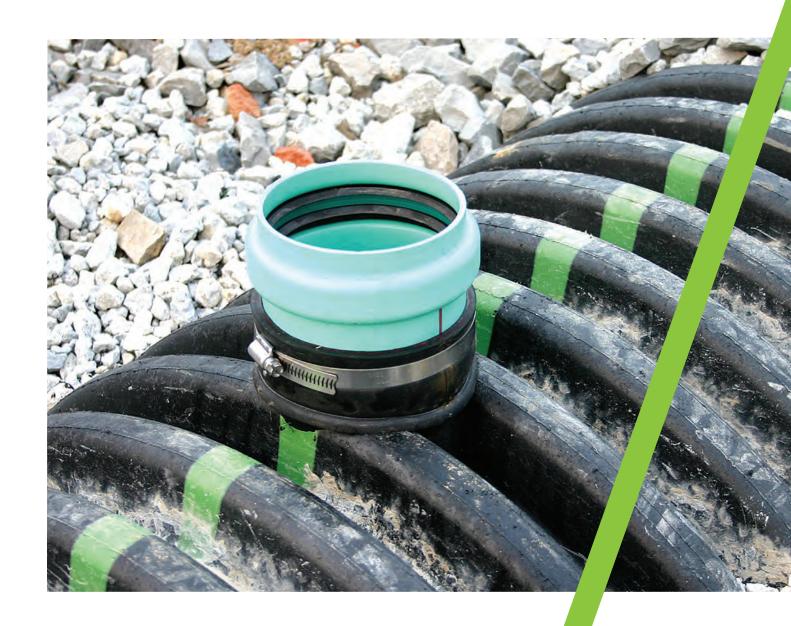



# **Inserta Tee Description**

Inserta Tee is a three-piece service connection consisting of a PVC hub, rubber sleeve and stainless steel band. Inserta Tee is compression fit into the cored wall of a mainline and requires no special tooling. Inserta Tees are designed to connect 2"-24" (51-600 mm) laterals to all known solid wall, profile, closed profile, corrugated pipe and manhole structures manufactured today.

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- Same great performance
  - reliable, a fitting you can count on
- Saves time
  - fast and efficient installation
- · Saves money
  - lower material and labor costs

# **Applications for OneFit**

- Roof drain leaders
- Structures
- Irrigation/Agriculture
- Nyloplast® drain basins
- Municipal repair/rehab
- Storm sewers
- Retention/Detention
- All pipe types
- Fiberlass manholes
- Rainwater harvesting

# **Stainless Steel Band**







**Rubber Sleeve** 

Gasketed PVC Hub



**Inserta Tee Lateral Connection** 



**Inserta Tee OneFit** 

# **Inserta Tee Applications**

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- Storm sewers
- Sanitary sewers
- Pipe bursting (HDPE/PVC)
- Sliplinging
- Fold-and-formed products
- Cured-in-place products
- Manholes
- · Wet wells
- Drainage
- Irrigation
- · Catch basins
- Electrical Vaults



**Storm Sewer** 

# **Inserta Tee Hole Saws**

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# **HOLE SAWS**

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2" (51 mm)	2%" (67 mm)
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24" (600 mm)	25 <sup>5</sup> / <sub>16</sub> " (643 mm)



**Hole Saws** 

# **ADS Inserta Tee Product Specification**

# Scope

This specification describes 2"-24" (50 to 600 mm) Inserta Tee service connections for use in gravity-flow sewer and drainage applications.

# **Product Requirements**

Inserta Tee service connections shall consist of a PVC hub, rubber sleeve and stainless steel band. Connections shall be a compression fit into the cored wall of a mainline pipe. hub shall be made from heavy-duty PVC material. Stainless steel clamping assembly shall be made from minimum 301 grade steel. Rubber sleeve and gasket, when applicable, shall meet the requirements of ASTM F477. Gaskets shall be installed by the manufacturer. The water-based solution provided the manufacturer shall be used during assembly. Do NOT use pipe lube.

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#### **Joint Performance**

Inserta Tee product includes a watertight bell connection meeting the requirements of ASTM D3212.

# **Field Pipe and Joint Performance**

To assure watertightness, field performance verification may be accomplished by testing in accordance with ASTM F2487, ASTM C969 or ASTM F1417\*. Appropriate safety precautions must be used when field testing any pipe material. Contact the manufacturer for recommended leakage rates.

#### Installation

Installation shall be in accordance with manufacturer's recommended installation guidelines. The use of installation methods or hole saws not purchased from Inserta Fittings will void the performance warranty of the product. Backfill around the Inserta Tee service connection shall be of the same material type and compaction level as specified for the mainline pipe installation. Contact your local representative or visit the website at www.adspipe.com for a copy of the latest installation guidelines.



Visit our website at **adspipe.com** for specifications (CAD or PDF), application details and our installation video, which may also be accessed by clicking on the QR code.

Product configuration & availability subject to change without notice. Product detail may differ slightly from actual product appearance.

\*Contact your local sales representative for acceptable watertight applications. Not all applications are standard and some may require additional technical assistance.







# **INSERTA TEE COMPARISON GUIDE**

This guide was designed to illustrate differences between INSERTA TEE and other products. It soon becomes obvious that this is truly a case of apples vs. oranges.

INSERTA TEEs are for new, rehabilitation, and repair installations and provide:

- Reduction in labor hours and pipe materials
- · Services connected where needed
- Watertight\*, testable connection every time
- Eliminates glues, epoxies, grout, tightening and retightening of bands









**Rubber Saddle Tee** 



Saddle




Other Product


Testing	tı a tı
Installation	V II v p n ii to b
Mainline Adaptibility	✓ V


Lateral Connection

Air testable in most pipes; meets the testing requirements of ASTM D3212 at 10.8 psi (75 kPa). Field testable to ASTM F2487, C969, and F1417.	Test information limited and does not meet ASTM D3212 at 10.8 psi (75 kPa).	Test information limited and does not meet ASTM D3212 at 10.8 psi (75 kPa).	Test information limited and does not meet ASTM D3212 at 10.8 psi (75 kPa).
installation instructions included with every tee to ensure coring the perfect hole. Minimum protrusion will not interfere with post-installation inspection. No straps or bands to re-tighten. No need to disturb backfill around the host pipe. Fast, effective, and easy to install.	No installation instructions on how to core the hole. Bands need to be installed around the host pipe and need to be re-tightened after 15 minutes. Backfill must be removed completely around the host pipe. Cannot be used on corrugated or ribbed host pipe.	Specific diameter hole required to keep boot from collapsing into the host pipe. Bands and straps must be tightened to specific torque and re-tightened after 15 minutes. Backfill must be removed completely around the host pipe. Cannot be used on corrugated or ribbed host pipe.	No installation instructions on how to cut the hole. Protrusion into mainline will interfere with post-installation video equipment or mandrels.
Will fit ALL common types and diameters of mainline pipe.	Limited to smooth exterior wall mainline pipe types.	Limited to smooth exterior wall mainline pipe types.	Limited mainline pipe types and diameters.
Will fit ALL common types of lateral pipe from 2"-30" (50-750 mm) diameters	Limited lateral sizes and types.	Limited lateral sizes and types.	Limited lateral sizes and types.

<sup>\*</sup>Contact your local sales representative for acceptable watertight applications. Not all applications are standard and some may require additional technical assistance.

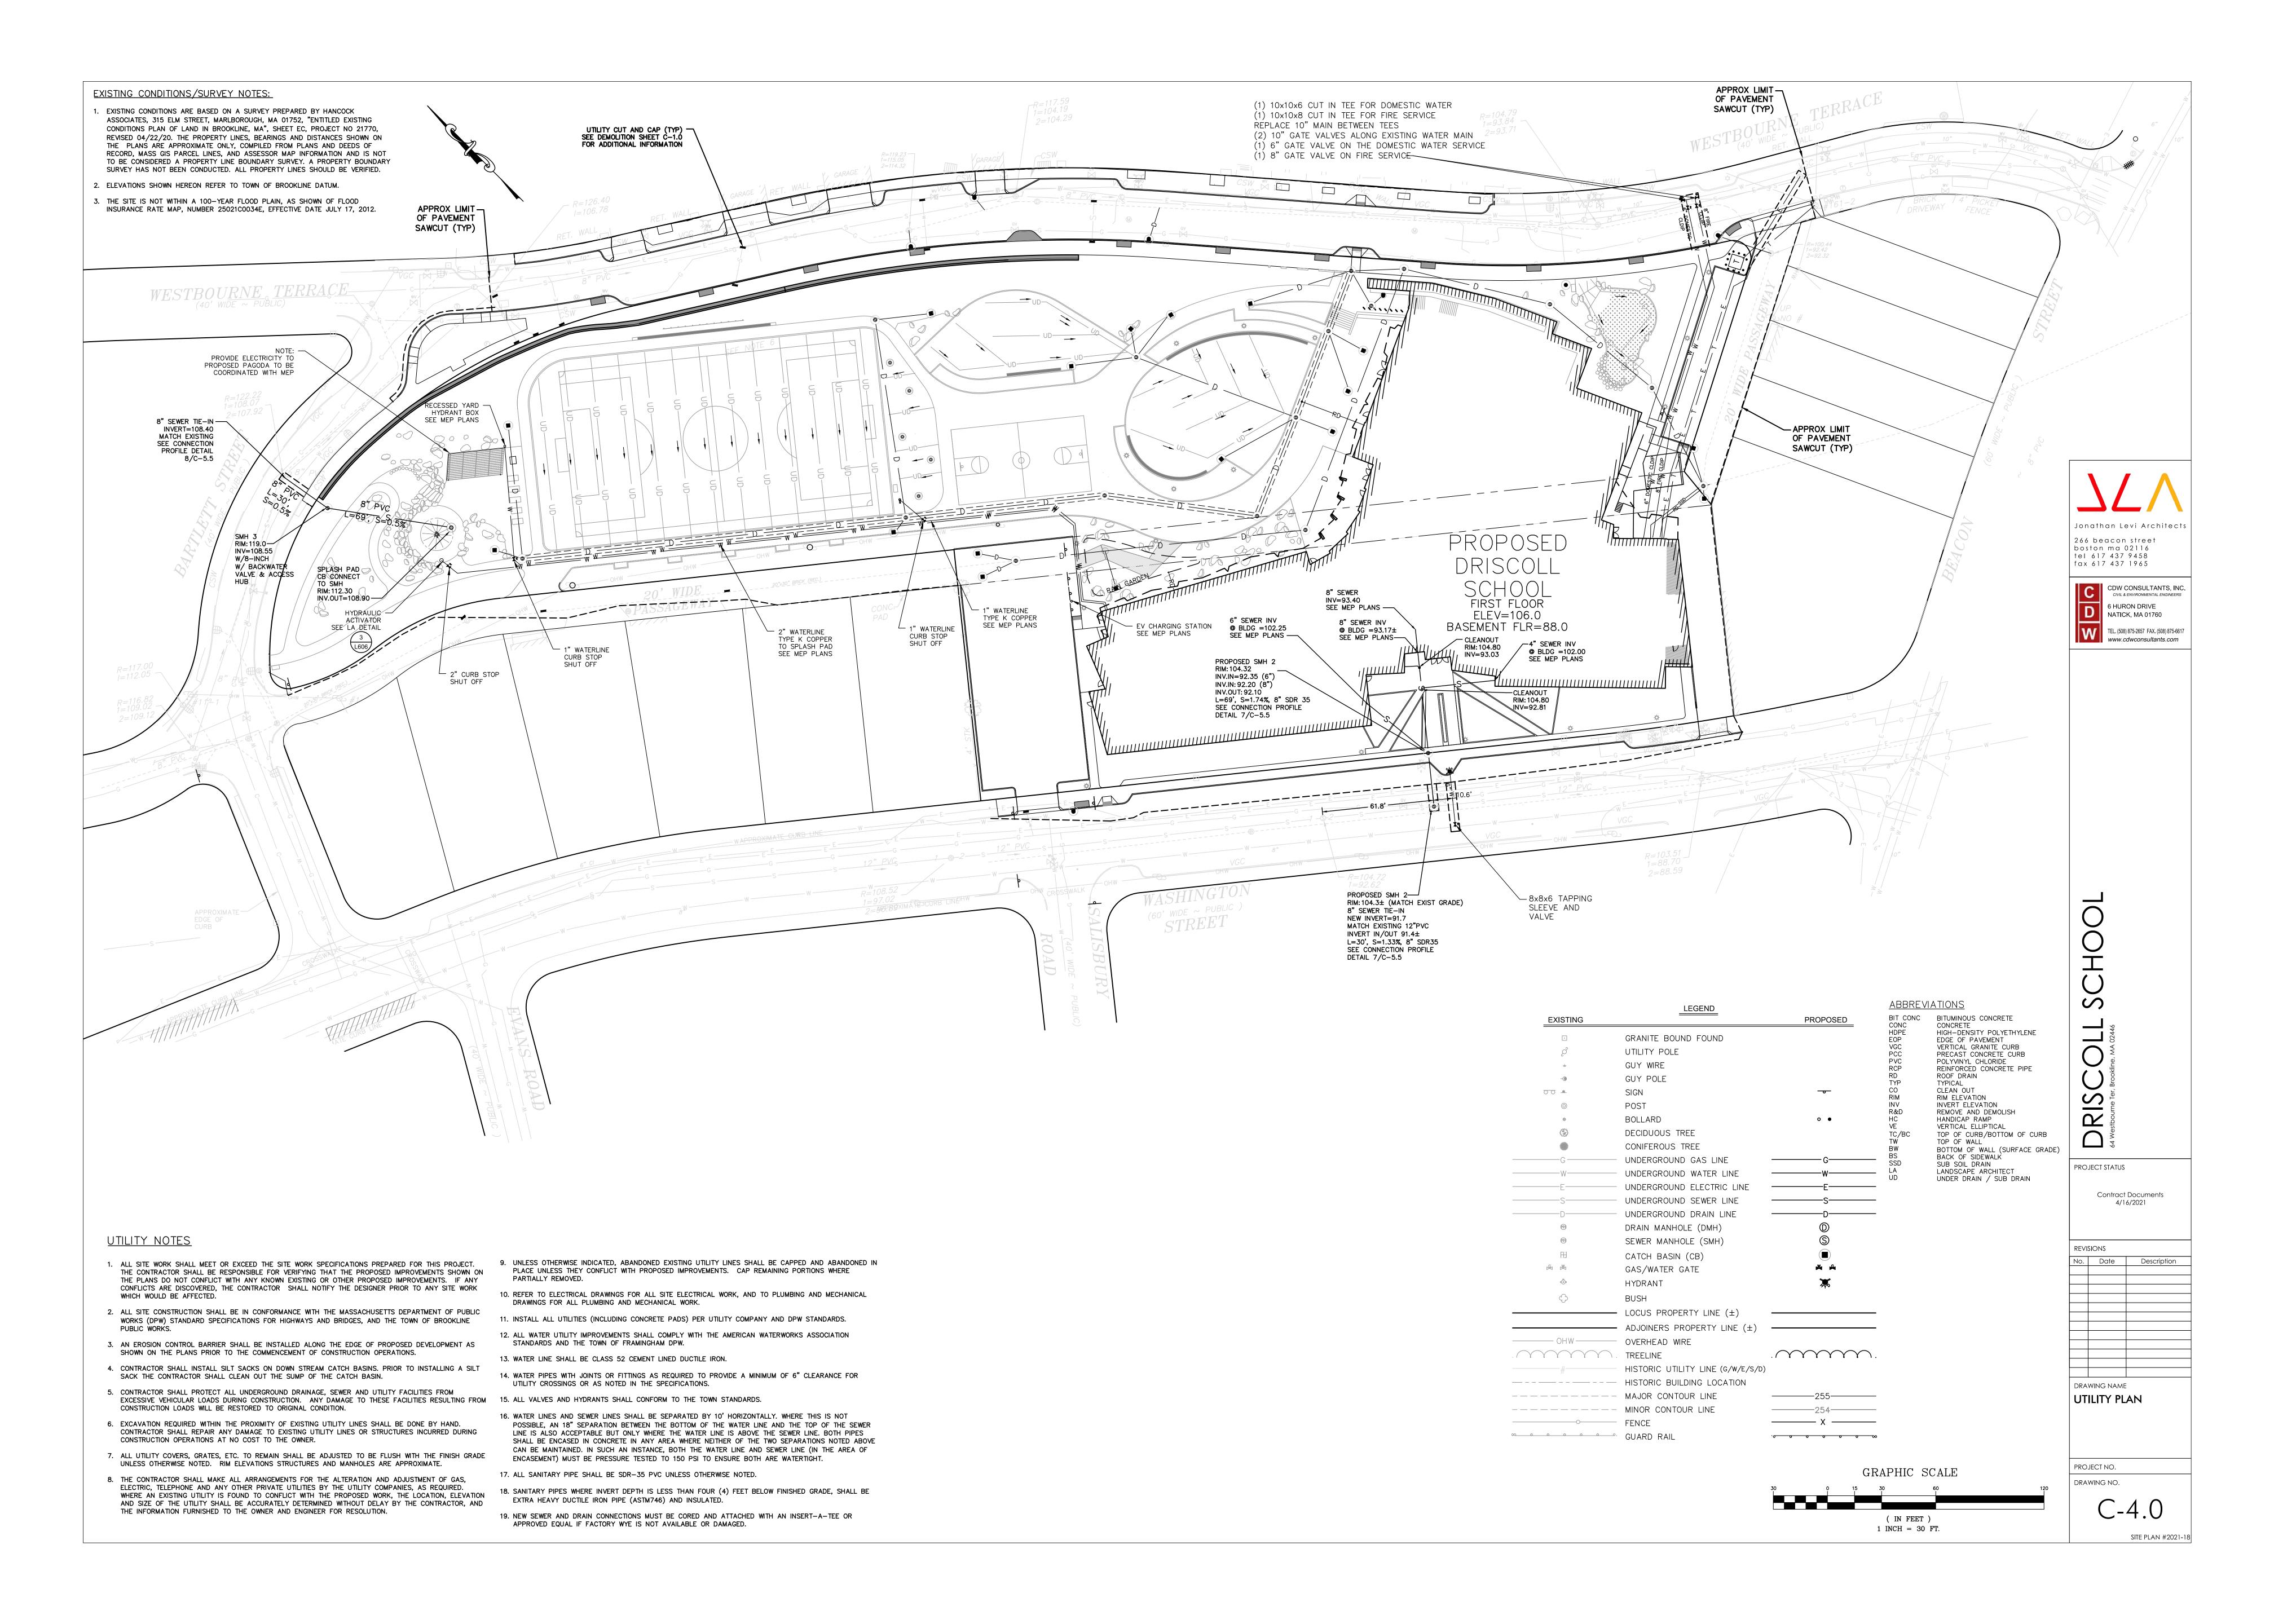

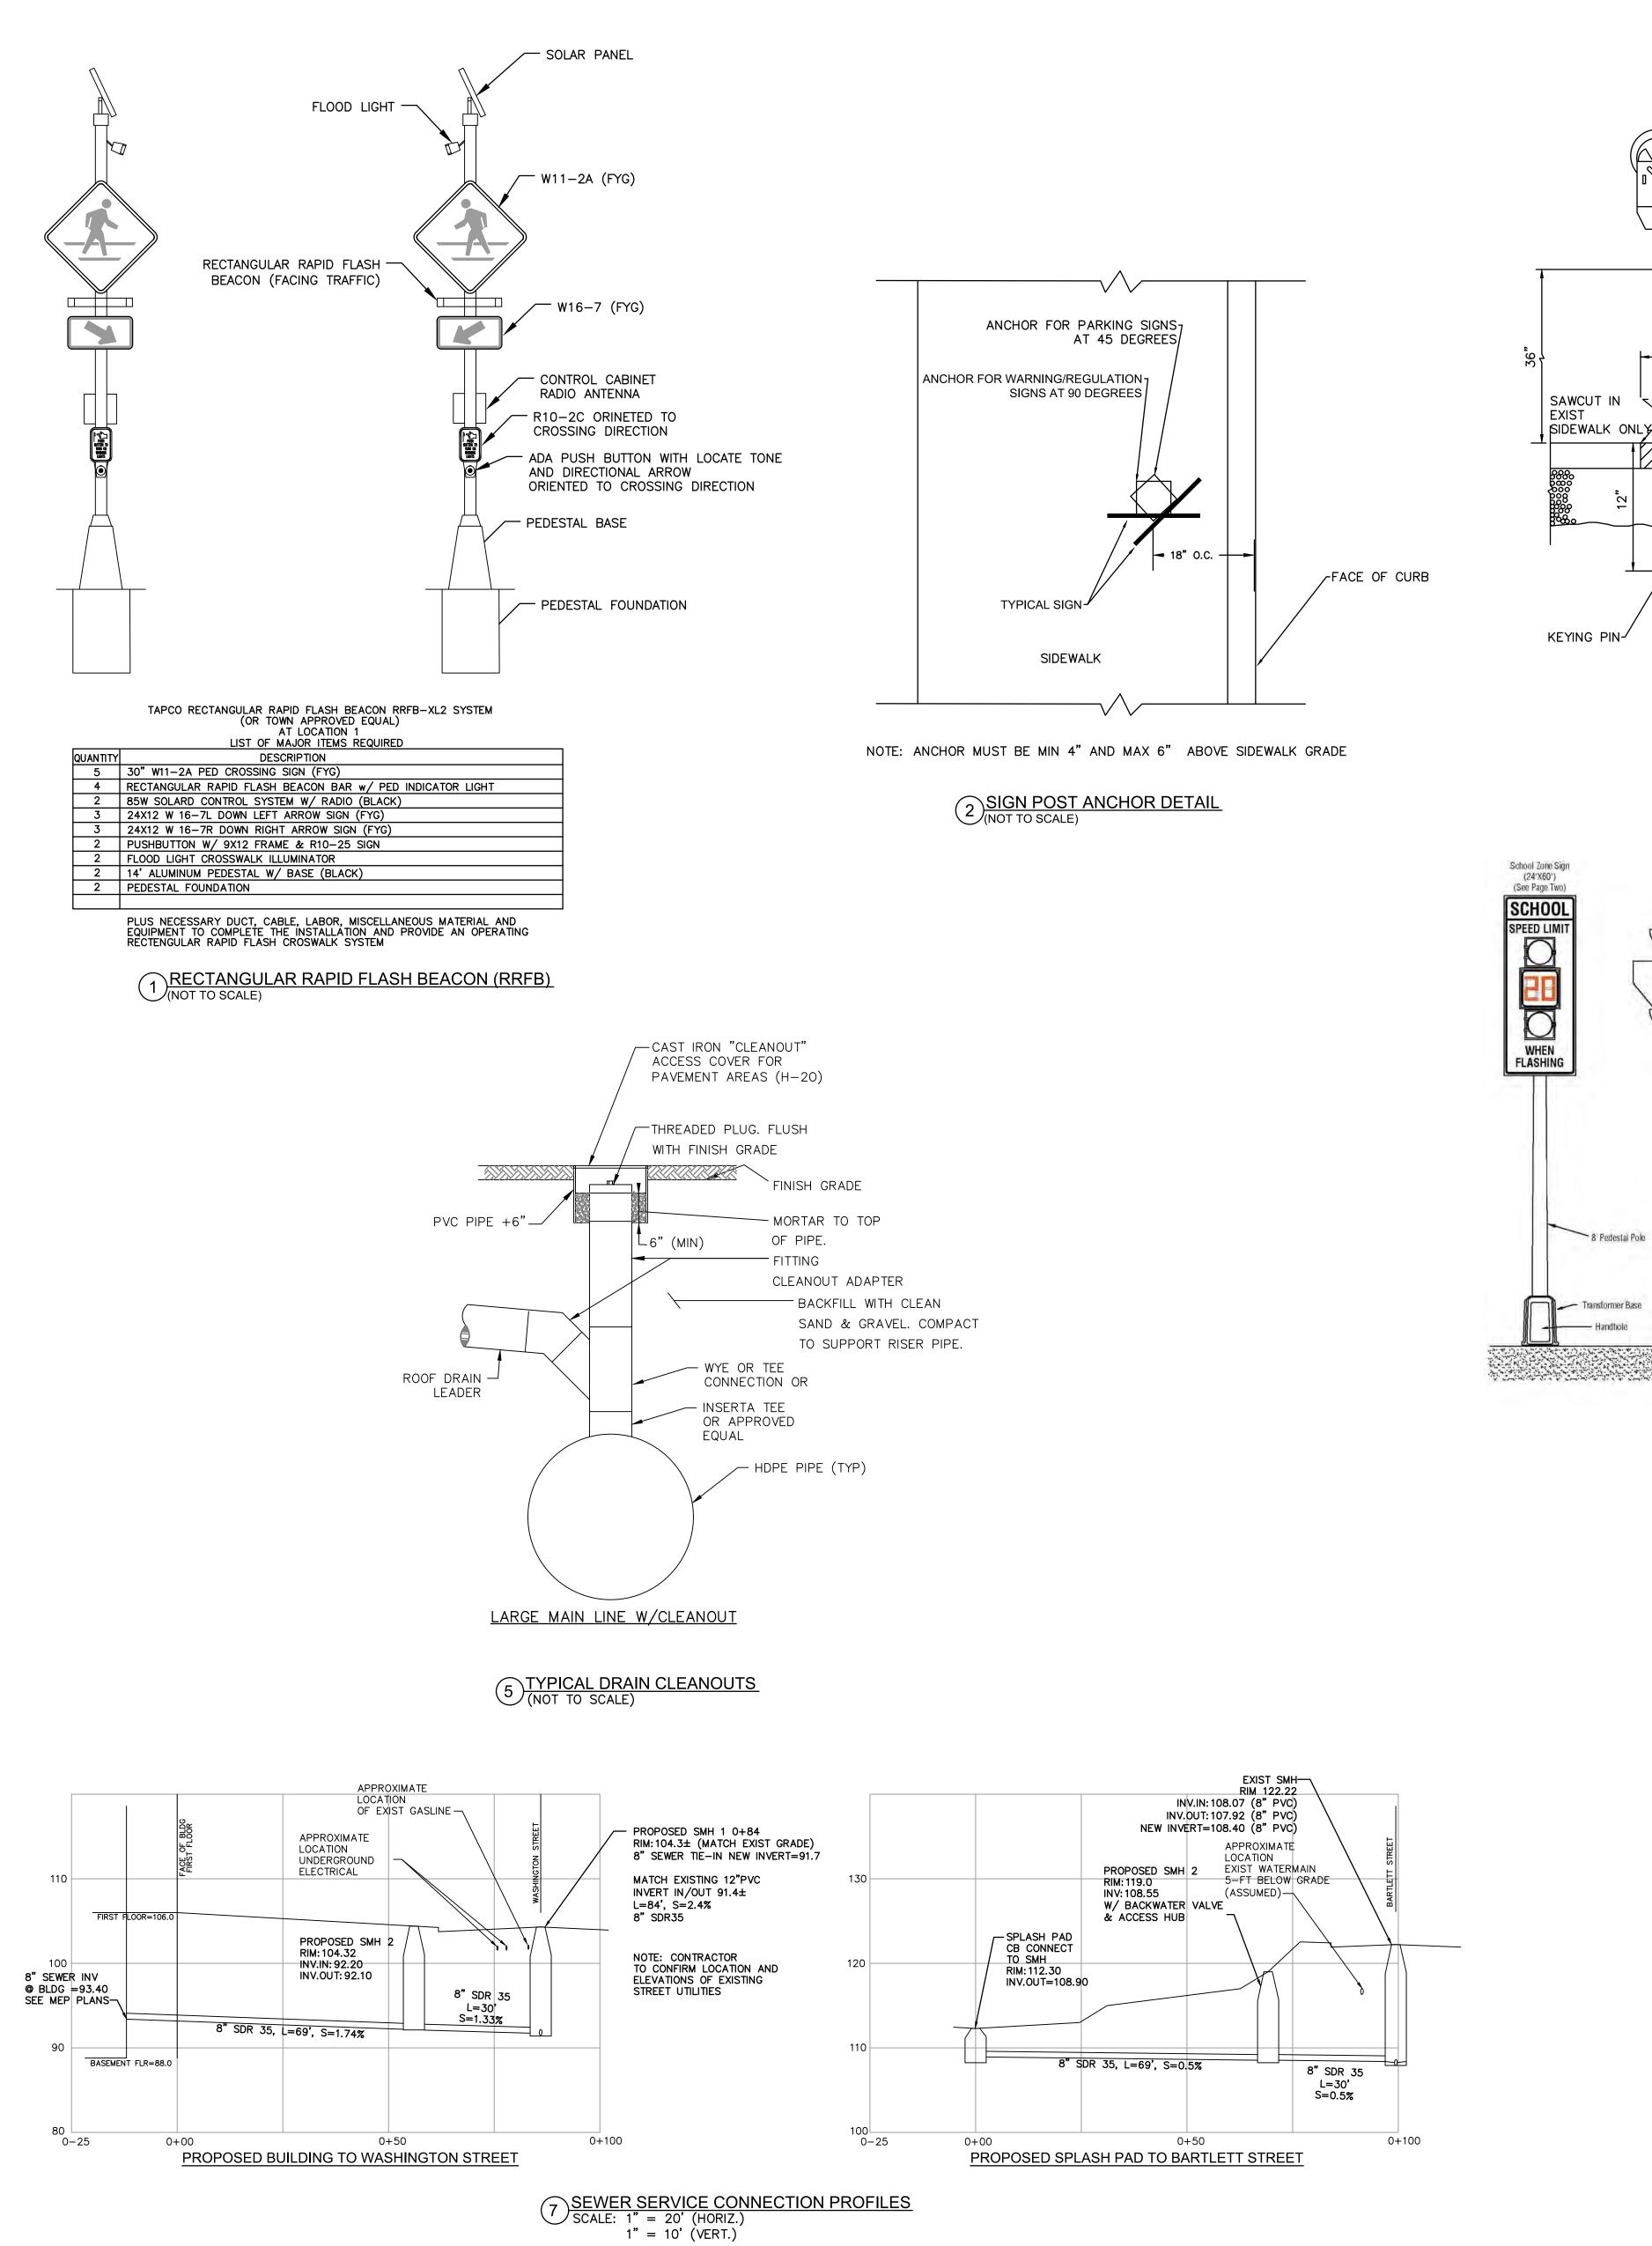

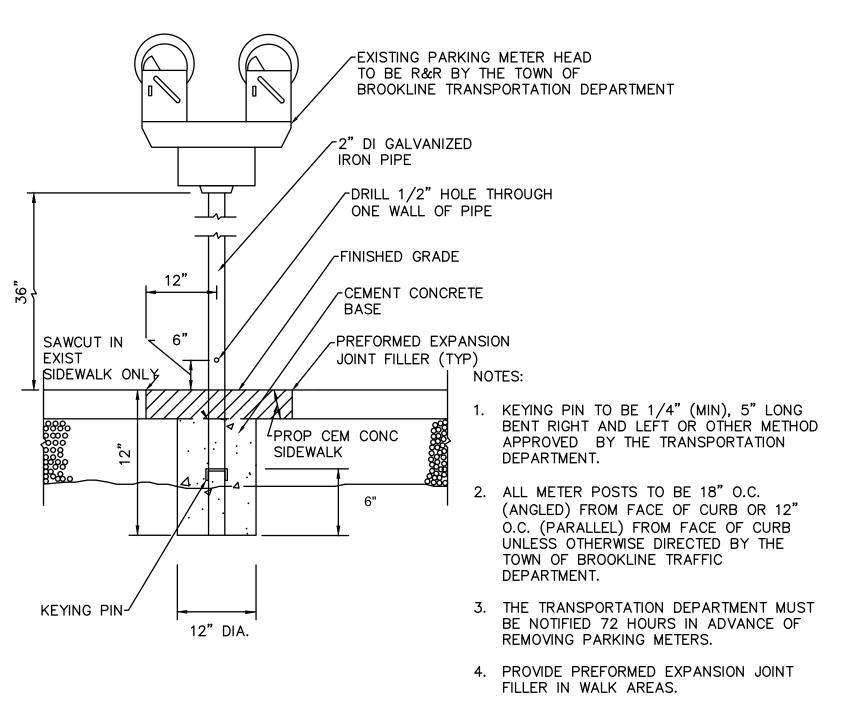

3 PARKING MEET POST DETAIL (NOT TO SCALE)

8" AMBER LED

8 BICYCLE SHARED LANE SYMBOL (NOT TO SCALE)

DIRECTION OF TRAVEL

(NOT TO SCALE)

12 3" Dia, Bolt 9"

Galvinized Steel Anchor Bolts 3/4°0x2'-1" Long With 3" - 90" Hook And 4" Threaded End


24" x 60" Retroreflective School Zone Signal Sign

SCHOOL

SPEED LIMIT

WHEN

FLASHING

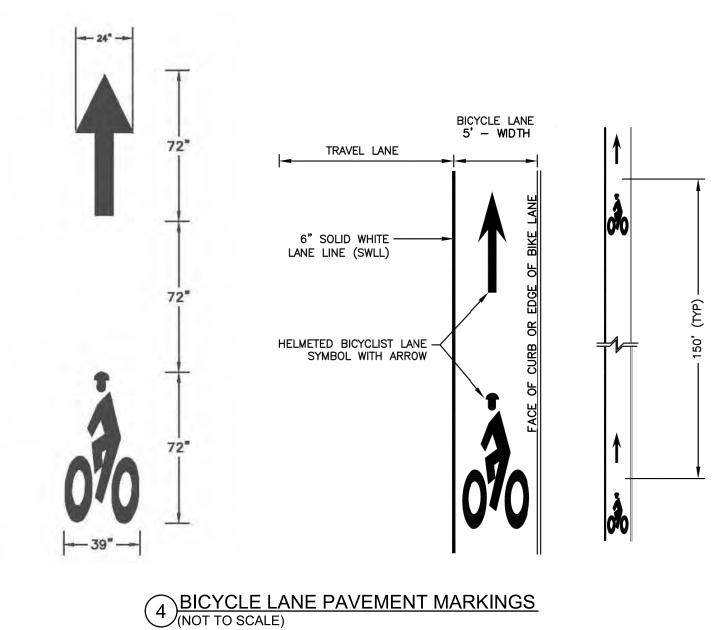

Dual Circuit Flasher

8" Signal Housing w/8" Yellow LED

12" Ped Housing w/"20" MPH LED & AP21T Time Switch

8" Signal Housing wi8" Yellow LED

SE-3310 1-Way Off-Set Post Top Assy

















# RIS

PROJECT STATUS

Contract Documents 4/16/2021 REVISED: 1-4-2021

REVISIONS					
No.	Date	Description			

DRAWING NAME CONSTRUCTION DETAILS

PROJECT NO.

DRAWING NO. C-5.5

SITE PLAN #2021-18

#### Gilbane Building Company **Authorization To Proceed**

ARCHITECT:



CONTRACT FOR: Brookline - Driscoll School

OWNER: Town of Brookline ADDRESS: 333 Washington Street

Brookline, MA, 02445

Jonathan Levi Architects LLC, Mark Warner

PROJECT NUMBER: ATP NO: rev 1 ATP VERSION: DATE OF ISSUANCE: SUBMITTED BY:

12/22/2021 Gilbane Building Company

J08864.000

ATP-0022

**ALTERNATE** TRACKING #:

The Contract Documents are hereby amended to include the additional Work described below, which is outside of the current scope of the Work and constitutes a change.

Upon Owner approval, Gilbane Building Company will proceed with the Work promptly.

Costs as incurred are in addition to the current contract Sum and will be invoiced and paid on a monthly basis and identified as separate items within the requisition. Once final cost of the Work involved and change in Sum and Time (if any) are fully determined, it will be submitted for inclusion in a final Change Order adjusting the Contract Sum and/or Time.

TITLE: RFI #139 Wide Style Door Leaf- Exterior Openings

DESCRIPTION: Per RFI #139 32 openings need to be changed from medium to wide style door due door hardware scheduled for the openings being in conflict.

#### Attachments:

Number	Description:	PCI Number	Change Date	Revision
00206143	REV 1-ATP-22 Backup	OS-00042	12/22/2021	Original Version
	Pricing			_

The Following information is provided by Gilbane Building Company

Method of determining change in Contract:

	☐ Cost Plus Fee	☐ Unit Price	Lump Sum
Other			

Change In Contract Sum Dollar Amount: \$10,893.00

√ Fixed ■ Maximum ■ Estimated Time and Material

> Change In Contract Time Time (Days): TBD

 Fixed ■ Maximum ■ Estimated

Job	PCI No.	Description	Phase Code	SubContractor	Amount	Accept?
J08864.000	OS-00042	Curtainwall		Salem Glass Company	\$9,911.00	C Yes C No

Job	PCI No.	Description	Phase Code	SubContractor	Amount	Accept?
J08864.000	OS-00042	Gen & Excess Liability Insurance	99.970.950050.Z		\$285.00	C Yes C No
J08864.000	OS-00042	Performance & Payment Bond	99.970.997000.Z		\$60.00	C Yes C No
J08864.000	OS-00042	Subcontractor Default Insurance	99.975.996000.Z		\$119.00	C Yes C No
J08864.000	OS-00042	Fee	99.999.999000.Z		\$518.00	C Yes C No
TOTAL FOR PCI No. OS-00042			\$10,893.00			

**Submitted Amt:** \$10,893.00

Gilbane Building C	ompanı
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# Gilbane Building Company

Signed: 12/22/2021 3:12:42 PM Eastern Standard Time - By:

Lynda Callahan (Senior Project Manager)

Gilbane Building Company: 10.126.8.52

onathan Levi Architects LLC

By:

Project Manager Title:

company: Jonathan Levi Architects

Date:

12/29/21

Printed Name: Carol Harris

.EFTFIELD, LLC

OPM Title:

Company: LeftField Project Management

Date:

Printed Name: Lynn Stapleton

own of Brookline

REVIEWED

By:

Title:

BROOKLINE Company:

2022 Date:

Printed Name:



Date: Revised: 12/20/2021

# **Michael Driscoll School**

# **Invoice Summary**

Change Number: OS-002

Description: RFI #139 Wide Syle Door Leaf- Exterior Openings

Bid Package / Scope of Work	Subcontractor	Cost
01A Interim/ Final Cleaning	GO Services	
01A Interim/ Final Cleaning 02A Abatement / Demolition	American Environmental	
03A Concrete	Marguerite	
05A Structural Steel	Supermetal	
06A Millwork	Polybois	
07C Metal Panels	Salem Glass	
07D Spray-on Fireproofing	Ricmor	
08A Curtainwall	Salem Glass	\$9,911.00
08C Doors, Frames, and Hardware	Kamco	
09A Drywall & General Trades	Central Ceilings	
09F Wood Flooring		
09F Wood Flooring 09G Resinous Flooring	Stonhard	
09H Carpeting	Capital Carpet	
10A Specialties		
10B Signage		
10C Overhead Doors	Baron	
11B Gym Equipment and Bleachers	Pappas	
11A Food Service Equipment	Kittredge	
12A Window Treatment		
31A Sitework	J. Derenzo	
Subguard Insurance (SDI)	1.20%	\$119.00
	Subcontractor Total	\$10,030.00

Bid Package / Scope of Work	Trade Contractor	Cost
04A Masonry	Fernandes Masonry	
05B Misc. Metals	United Steel	
07A Waterproofing	Armani	
07B Roofing and Flashing	JD Rivet	
08B Glass and Glazing	Kapiloff	
07A Waterproofing 07B Roofing and Flashing 08B Glass and Glazing 09B Resilient Flooring	CJM Services	
09C Tile	Pavilion	
09D Painting	Color Concepts	
09E Acoustic Tile	Cheviot	
14A Elevator	Delta Beckwith	
21A Fire Protection	Johnson Controls	
22A Plumbing	PJ Kennedy	
23A HVAC	PIKennedy	
26B Electrical	Wayne J. Griffin Electric	
Bond (included in above cost)		
	Trade Contractor Total	\$0.00

Subcontractor/Trade Contractor Total	-	\$10,030.00
General Conditions (x hours Engineering x hours Superintendent)		\$0.00
CM Bond	0.600%	\$60.00
Total CCIP	2.750%	\$285.00
Fee	5.00%	\$518.00
TOTAL	-	\$10,893.00

# **Change Order Request**



Salem Glass Company 3 Technology Way, Salem, MA Tel: (978) 744-5177

Fax: (978) 745-4036

SGC Project No: 8530 GC Project No: #J08864.0

Subcontract No. -

SGC Project Manager: Jeff R Ray

To: Gilbane Building Co.

10 Channel Center Street Suite 100

Boston, MA.

Project Address: 64 Westbourne Terrace

Project Name: Michael Driscoll school

Brookline, MA.

Attn: Colleen Shouldice

Salem Glass hereby requests that the following changes be made in subcontract between us and governed by all the terms and conditions of the subcontract.

Contractors Ref #: N/A SGC CO No: 3

# Scope

Due to specific hardware requirements we Need to change All the Medium style doors to Wide style Insulpour doors (32 door leafs) per attached Hardware schedule

Material Only		S.F/Hrs x	Cost	Total
Kawneer 500T Insulpour doors		32 x	\$ 281.55	\$ 9,009.60
		0 x	\$ -	\$ -
		0 x	\$ -	\$ -
Equipment	Scissor lift	0 x	\$ -	\$ -
Delivery	Delivery	0 x	\$ -	\$ -
Labor	Shop Labor	0 x	\$ -	\$ -
	Field Labor	0 x	\$ -	\$ -
	Sub Tier OH&P	0 x	\$ -	\$ -
	Overhead & Profit	0 x	10%	\$ 900.96
	Tax		6.25%	
				\$ 9,910.56

This Subcontract Revision Total \$ 9,911.00

This Change Order constitutes complete agreement regarding compensation to Salem Glass Company for both the extension of time and additional cost for the above additional work. This Change Order is limited to the material and labor as described above. Salem Glass Company may seek additional compensation for any deviation from the scope that generates an additional cost to the Salem Glass Company.

Gilbane	Building Co.		Salem Glas	s Company
By: (Duly Authorized)		<b>-</b>	(Duly Authorized)	
		_	Jeff Ray	20-Dec-21
(Print Name)	(Date)		(Print Name)	(Date)

# REVISED QUOTE TO SHOW INCREASE DOOR SIZE



# **Material Proposal**

Estimator: Anita Justus
Phone: 540-432-7575

Fax:

Job Name: 8530 Michael Driscoll School Doors

Job Number: **1028004E-001** 

Date Sent: 11/01/2021

SALEM GLASS CO

3 Technology Way SALEM, MA, 01970 E-mail: anita.justus@arconic.com

Sales Rep: Daniel R Triggs
Phone: 603-218-9917

E-mail: daniel.triggs@arconic.com

Attention: Danny Blake

Phone: 978.744.5177 Fax: 978.745.4036

Cust #: 3641

Cust Email: dblake@salemglass.com

# This Material Proposal is based on:

Customer email dated 10/20

Total Base Bid: \$USD 271,697.00

# This Material Proposal includes:

# DOES NOT INCLUDE RECYCLED CONTENT BILLET

Item Description:		
1. Qualifications		

Quoted doors only as no frames are included on request.

Quoted all doors as 500T due to some having to be wide stile due to hardware requirements.

Commercial grade swing doors do not form a watertight enclosure. While somewhat weather resistant these doors have not been tested for water performance. To date, AAMA does not even have a water test for this type of door.

All head/sill/jambs must provide adequate structural support in which to anchor the Kawneer framing using standard anchorage. This proposal does not include any custom anchoring systems. If these are required, an add to the price will be required if they are to be provided by Kawneer.

Hardware not provided by Kawneer has not undergone a hardware compatibility check for the quoted doors. It is the customer's responsibility to review hardware compatibility and request changes based upon the results.

NOTE: This estimate is based on customer supplied material list and takeoff. It is the customer's responsibility to verify that all quoted products meet the need and specifications of the project.

\*\*Silicone Setting Blocks\*\* This quotation is based on using standard EPDM setting blocks and side blocks. If the products in this proposal are being glazed with Viracon glass, please check with a Viracon representative on compatibility with EPDM. Viracon may require the use of silicone setting and side blocks which would result in an added price and an increase in lead times.

#### Finish:

This estimate is based on (1) 2-Coat Sunstorm Finish (non-exotic, non-metallic, non-sun storm, non-white) - any other paint finish may result in an add to the estimate.

# Stock Length:

All shop drawings, engineering and material take-off are by the customer. Customer will be responsible for providing an itemized stock length list of material at purchase order time.





# **Material Proposal**

Estimator: Anita Justus
Phone: 540-432-7575

Fax:

Job Name: 8530 Michael Driscoll School Doors

Job Number: 1005494E-003

Date Sent: 05/18/2021

3 Technology Way SALEM, MA, 01970

E-mail: anita.justus@arconic.com

Sales Rep: Daniel R Triggs
Phone: 603-218-9917

E-mail: daniel.triggs@arconic.com

SALEM GLASS CO Attention: Danny Blake

Phone: 978.744.5177 Fax: 978.745.4036

Cust #: 3641

Cust Email: dblake@salemglass.com

# This Material Proposal is based on:

Revised per customer's E-mail take off- Received 4/23/21

Total Base Bid: \$USD 271,697.00

# This Material Proposal includes:

# DOES NOT INCLUDE RECYCLED CONTENT BILLET

Item Description:		
1. Qualifications		

Quoted doors only as no frames are included on request.

Commercial grade swing doors do not form a watertight enclosure. While somewhat weather resistant these doors have not been tested for water performance. To date, AAMA does not even have a water test for this type of door.

All head/sill/jambs must provide adequate structural support in which to anchor the Kawneer framing using standard anchorage. This proposal does not include any custom anchoring systems. If these are required, an add to the price will be required if they are to be provided by Kawneer.

Hardware not provided by Kawneer has not undergone a hardware compatibility check for the quoted doors. It is the customer's responsibility to review hardware compatibility and request changes based upon the results.

NOTE: This estimate is based on customer supplied material list and takeoff. It is the customer's responsibility to verify that all quoted products meet the need and specifications of the project.

\*\*Silicone Setting Blocks\*\* This quotation is based on using standard EPDM setting blocks and side blocks. If the products in this proposal are being glazed with Viracon glass, please check with a Viracon representative on compatibility with EPDM. Viracon may require the use of silicone setting and side blocks which would result in an added price and an increase in lead times.

#### Finish:

This estimate is based on (1) 2-Coat Sunstorm Finish (non-exotic, non-metallic, non-sun storm, non-white) - any other paint finish may result in an add to the estimate.

# Stock Length:

All shop drawings, engineering and material take-off are by the customer. Customer will be responsible for providing an itemized stock length list of material at purchase order time.



# **Material Proposal**

Estimator: Anita Justus

Phone: 540-432-7575

Fax:

8530 Michael Driscoll School Doors

Job Number: 1028004E-001

Date Sent: 11/01/2021

E-mail: anita.justus@arconic.com

Sales Rep: Daniel R Triggs Phone: 603-218-9917

E-mail: daniel.triggs@arconic.com

SALEM GLASS CO

3 Technology Way SALEM, MA, 01970 Attention: Danny Blake

Phone: 978.744.5177 Fax: 978.745.4036

Cust #: 3641

Cust Email: dblake@salemglass.com

# This Material Proposal is based on:

Customer email dated 10/20

# This Material Proposal includes:

# DOES NOT INCLUDE RECYCLED CONTENT BILLET

Item Description:		
1. Qualifications		

Quoted doors only as no frames are included on request.

Quoted all doors as 500T due to some having to be wide stile due to hardware requirements.

Commercial grade swing doors do not form a watertight enclosure. While somewhat weather resistant these doors have not been tested for water performance. To date, AAMA does not even have a water test for this type of door.

All head/sill/jambs must provide adequate structural support in which to anchor the Kawneer framing using standard anchorage. This proposal does not include any custom anchoring systems. If these are required, an add to the price will be required if they are to be provided by Kawneer.

Hardware not provided by Kawneer has not undergone a hardware compatibility check for the quoted doors. It is the customer's responsibility to review hardware compatibility and request changes based upon the results.

NOTE: This estimate is based on customer supplied material list and takeoff. It is the customer's responsibility to verify that all quoted products meet the need and specifications of the project.

\*\*Silicone Setting Blocks\*\* This quotation is based on using standard EPDM setting blocks and side blocks. If the products in this proposal are being glazed with Viracon glass, please check with a Viracon representative on compatibility with EPDM. Viracon may require the use of silicone setting and side blocks which would result in an added price and an increase in lead times.

#### Finish:

This estimate is based on (1) 2-Coat Sunstorm Finish (non-exotic, non-metallic, non-sun storm, non-white) - any other paint finish may result in an add to the estimate.

# Stock Length:

All shop drawings, engineering and material take-off are by the customer. Customer will be responsible for providing an itemized stock length list of material at purchase order time.

Job Number: 1028004E-001

# Freight:

Freight for this quotation is determined for shipment to zip code 01970. If the shipment zip code is different from what is quoted, please contact your Project Manager. If your ship to zip code changes, the freight value is subject to change.

The products in this proposal are based on material shipping in:

1 Shipments of Doors

If additional shipments are required, extra freight charges will apply and your Kawneer Project Manager should be notified.

Estimator's Disclaimer:


This pricing is based on Kawneer's interpretation of the customer's take-off and quantities. Prior to order entry, verification of part numbers, quantities, and finishes listed on the proposal is the responsibility of the customer. Any changes in part numbers, quantities, or finishes will require a change in the quoted amount.

\*\*\*\*\*\*


MATERIALTAKE OFF NOT BY KAWNEER: CUSTOMER SUPPLIED MATERIAL LIST REQUIRED AT TIME OF ORDER ENTRY.

#### NOT INCLUDED


Brakes, Extended Warranties, Fabrication, Fabrication prior to finishing, cutting to size of stock lengths, flashing, Glass & Glazing labor, Material Take-Off, Mock Ups, P.E. Licensed Stamp, Perimeter Anchors, Protective/Strippable Coatings, Shop Drawings, Special or Field Testing, Laboratory Testing, Special Samples, Steel Reinforcing, Concealed Flashing, Structural Calculations, Provisions for LEED

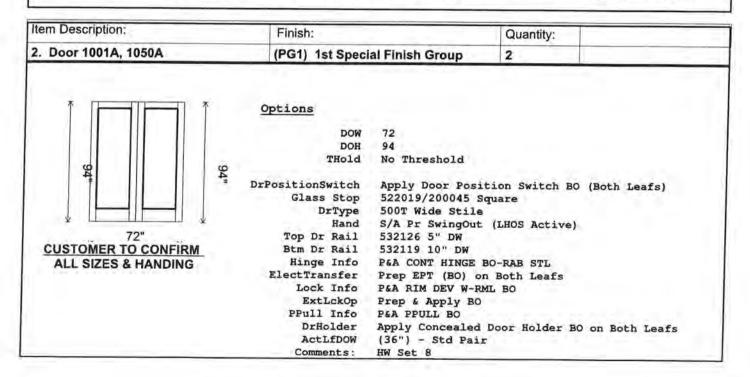


Item Description:	Finish:		Quantity:	
3. Door 1001C, 1050C	(PG1) 1st Speci	1) 1st Special Finish Group		
72" CUSTOMER TO CONFIRM ALL SIZES & HANDING	DOW DOH THOID  DrPositionSwitch Glass Stop DrType Hand Top Dr Rail Btm Dr Rail Hinge Info ElectTransfer Lock Info ExtLckOp PPull Info DrHolder ActLfDOW Comments:	S/A Pr SwingOut 532126 5" DW 532119 10" DW P&A CONT HINGE E Prep EPT (BO) on P&A RIM DEV W-RM Prep & Apply BO	cion Switch BO quare  (LHOS Active)  O-RAB STL Both Leafs L BO  Door Holder BO	

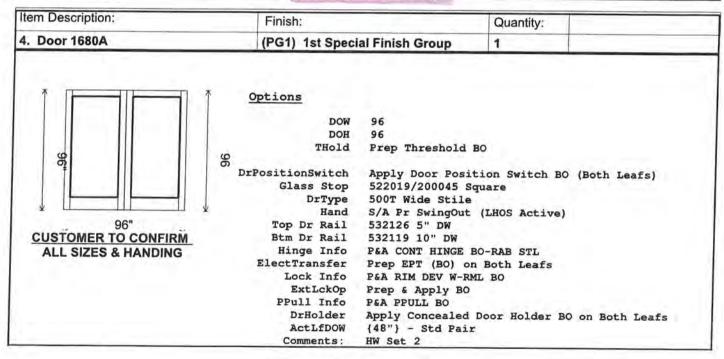

Item Description:	Finish:		Quantity:	
5. Door 1001B, 1050B	(PG1) 1st Speci	al Finish Group	2	
36" CUSTOMER TO CONFIRM ALL SIZES & HANDING	Options  DOW DOH THOID THOID  DrPositionSwitch Glass Stop DrType Hand Top Dr Rail Btm Dr Rail Hinge Info ElectTransfer Lock Info ExtLckOp PPull Info DrHolder Comments:	500T Wide Stile LHOS (H/R Swings 532126 5" DW 532119 10" DW P&A CONT HINGE I Prep EPT (BO) P&A RIM EXIT DEV Prep & Apply BO P&A PPULL BO	tion Switch BO quare Out) BO-RAB STL	

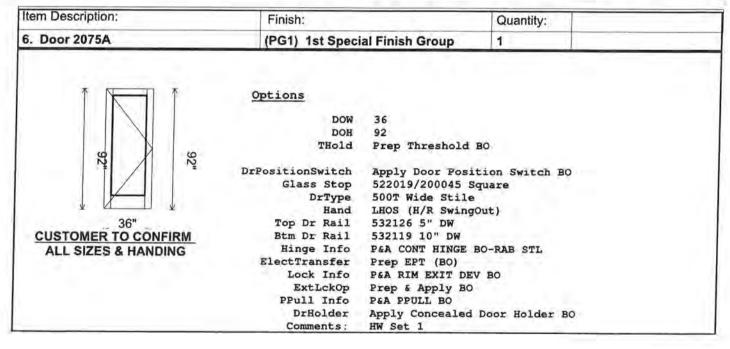


Item Description:	Finish:		Quantity:	
7. Door 1550A, 1550B, 1550C	(PG1) 1st Speci	ial Finish Group	3	
26" CUSTOMER TO CONFIRM ALL SIZES & HANDING	Options  DOW DOH THOID  DrPositionSwitch Glass Stop DrType Hand  Top Dr Rail Btm Dr Rail Hinge Info ElectTransfer Lock Info ExtLckOp PPull Info DrHolder Comments:	500T Wide Stile LHOS (H/R SwingO 532126 5" DW 532119 10" DW	tion Switch BO quare Out) BO-RAB STL	

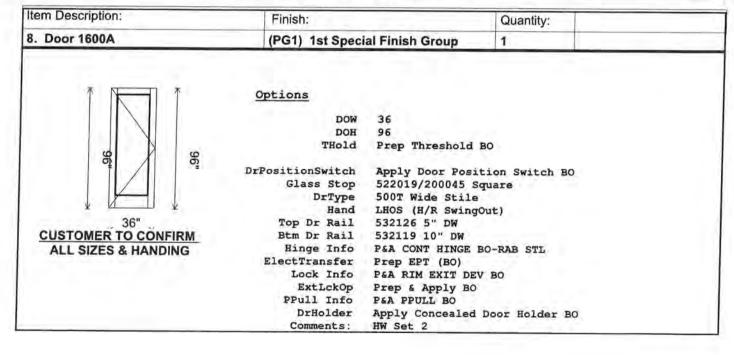



Job Number: 1028004E-001

Item Description:	Finish:	Finish:		
9. Door 2085A	(PG1) 1st Speci	ial Finish Group	1	
CUSTOMER TO CONFIRM ALL SIZES & HANDING	Options  DOW DOH THOID THOID  DrPositionSwitch Glass Stop DrType Hand Top Dr Rail Btm Dr Rail Hinge Info ElectTransfer Lock Info ExtLckOp PPull Info DrHolder Comments:	500T Wide Stile LHOS (H/R Swings 532126 5" DW 532119 10" DW P&A CONT HINGE F Prep EPT (BO) P&A RIM EXIT DEV Prep & Apply BO P&A PPULL BO	tion Switch BO quare Out) BO-RAB STL	

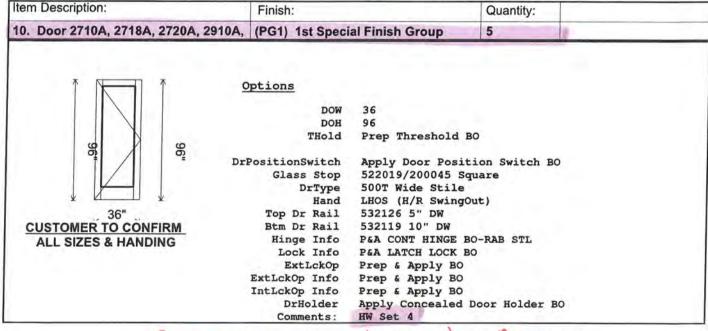


Need TO Be wide Style door Because of Storeroom Luckset lever

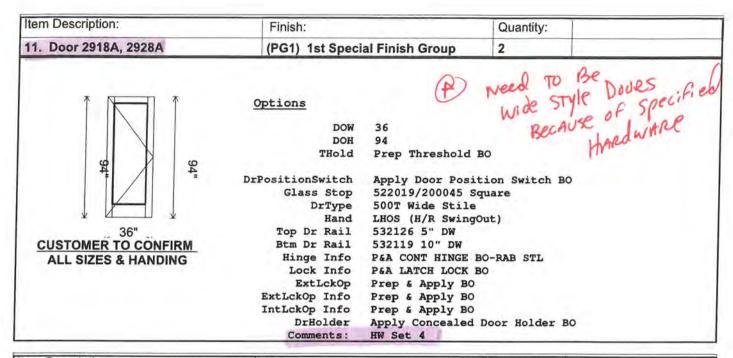

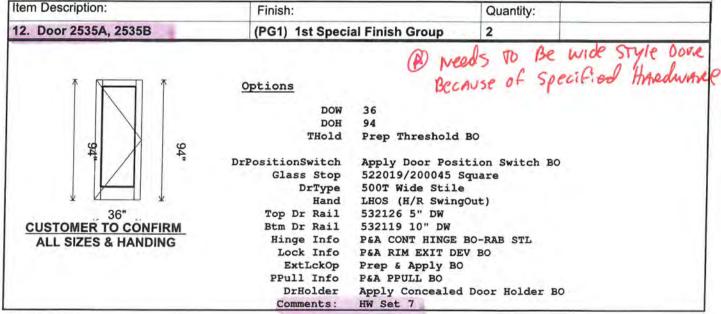

Item Description:	Finish:		Quantity:	
13. Door 1001D, 1050D	(PG1) 1st Speci	al Finish Group	2	
CUSTOMER TO CONFIRM ALL SIZES & HANDING	Options  DOW DOH THOID THOID  DrPositionSwitch Glass Stop DrType Hand Top Dr Rail Btm Dr Rail Hinge Info ElectTransfer Lock Info ExtLckOp PPull Info DrHolder Comments:	500T Wide Stile LHOS (H/R Swing) 532126 5" DW 532119 10" DW P&A CONT HINGE I Prep EPT (BO) P&A RIM EXIT DEN	quare Out) SO-RAB STL	

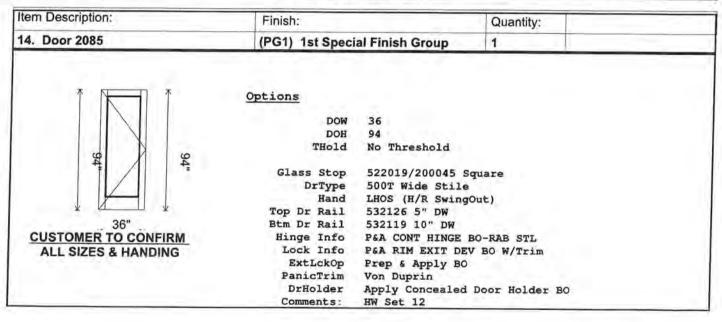

Job Number: 1028004E-001

tem Description:	Finish:		Quantity:	
15. Door 1040A, 1328A, 2070A	(PG1) 1st Speci	al Finish Group	3	
36" CUSTOMER TO CONFIRM ALL SIZES & HANDING	Options  DOW DOH THOID  DrPositionSwitch Glass Stop DrType Hand Top Dr Rail Btm Dr Rail Hinge Info ElectTransfer Lock Info ExtLckOp PPull Info DrHolder Comments:	LHOS (H/R Swing( 532126 5" DW 532119 10" DW P&A CONT HINGE E Prep EPT (BO) P&A RIM EXIT DEV	tion Switch BO quare Out) BO-RAB STL	

Item Description:		
16. Outside Hardware		

#### HW SET 1.000 ARCHSET 1 1 DOOR#: 1050B 1 DOOR#: 1001B CAN STRY @ Medium STyle door if wanted DOOR SIZE: 36" X 94" X 1.75"+0.5" DOOR TYPE: (2) SINGLE MEDIUM STILE THERMAL ALUMINUM DOOR DESC: 350T TOTAL MATERIAL REQUIRED FOR THE ABOVE HARDWARE SET: 2 IVES CONTINUOUS HINGE 93" 628 2 VON DUPRIN POWER TRANSFER SP28 2 VON DUPRIN ELEC RIM EXIT 36" X 1.75"+0.5" 626 2 SCHLAGE FSIC RIM CYLINDER 626 1 SCHLAGE CONTROL KEY 2 BY OTHERS PERMANENT KEYED CORE 48" O.A. X 42" CTC X 1.75"+0.5" 2 ROCKWOOD OFFSET PULL 630 2 GLYNN JOHNSON CONC OH STOP 36" 630 2 LCN SURFACE OPERATOR 689 NOTE: THE 4642 OPERATOR IS INTENDED FOR OCCASIONAL ELECTRIC ACTIVATION. IF THIS IS A HIGH TRAFFIC DOOR, WE RECOMMEND USING THE 9500 SERIES ELECTROMECHANICAL SENIOR SWING. NOTE TO BE FLUSH CEILING MTD. FOR USE IN CONJUNCTION WITH O.H. STOP 2 LCN WALL ACTUATOR 2 LCN DUAL VEST ACTUATOR 2 ZERO DRIP CAP 40" CLR 2 DOOR MFG MFG STD WEATHERING 2 ZERO DOOR SWEEP/DRIP 36" CLR 2 DOOR MFG THRESHOLD 2 SCHLAGE ELEC SE DOOR POSITION SWITCH 2 BY OTHERS BY SECURITY 2 VON DUPRIN POWER SUPPLY 1 SPG ENGINEERIN CUSTOM DIAGRAM 1 SPG ENGINEERIN POINT TO POINT HW SET 1.1 ARCHSET 1 1 DOOR#: 2075A

```
DOOR SIZE: 36" X 92" X 1.75"+0.5"
                                                                    style doves it
                                       CAN STAY AS MEdium
  DOOR TYPE: (1) SINGLE MEDIUM STILE
   THERMAL ALUMINUM
  DOOR DESC: 350T
  TOTAL MATERIAL REQUIRED FOR THE ABOVE HARDWARE SET:
  1 IVES CONTINUOUS HINGE 91" 628
  1 VON DUPRIN POWER TRANSFER SP28
  1 VON DUPRIN ELEC RIM EXIT 36" X 1.75"+0.5" 626
  1 SCHLAGE FSIC RIM CYLINDER 626
  1 SCHLAGE CONTROL KEY
  1 BY OTHERS PERMANENT KEYED CORE
  48" O.A. X 42" CTC X 1.75"+0.5"
  1 ROCKWOOD OFFSET PULL 630
  1 GLYNN JOHNSON CONC OH STOP 36" 630
  1 LCN SURFACE OPERATOR 689
  NOTE: THE 4642 OPERATOR IS INTENDED FOR OCCASIONAL ELECTRIC ACTIVATION. IF THIS
  IS A HIGH TRAFFIC DOOR, WE RECOMMEND USING THE 9500 SERIES ELECTROMECHANICAL SENIOR SWING.
  NOTE TO BE FLUSH CEILING MTD. FOR USE IN CONJUNCTION WITH O.H. STOP
  1 LCN WALL ACTUATOR
  1 LCN DUAL VEST ACTUATOR
  1 ZERO DRIP CAP 40" CLR
  1 DOOR MFG MFG STD WEATHERING
 1 ZERO DOOR SWEEP/DRIP 36" CLR
 1 DOOR MFG THRESHOLD
 1 SCHLAGE ELEC SE DOOR POSITION SWITCH
 1 BY OTHERS BY SECURITY
 1 VON DUPRIN POWER SUPPLY
 1 SPG ENGINEERIN CUSTOM DIAGRAM
 1 SPG ENGINEERIN POINT TO POINT
 HW SET 2.000 ARCHSET 2
 1 DOOR#: 1550A
 1 DOOR#: 1550B
                                            STAY & medium STyle dours if Required
 1 DOOR#: 1550C
 DOOR SIZE: 36" X 94" X 1.75"+0.5"
 DOOR TYPE: (3) SINGLE MEDIUM STILE
 THERMAL ALUMINUM
 DOOR DESC: 350T
 TOTAL MATERIAL REQUIRED FOR THE ABOVE HARDWARE SET:
 3 IVES CONTINUOUS HINGE 93" 628
 3 VON DUPRIN POWER TRANSFER SP28
 3 VON DUPRIN RIM EXIT 36" X 1.75"+0.5" 626
3 SCHLAGE FSIC RIM CYLINDER 626
 1 SCHLAGE CONTROL KEY
3 BY OTHERS PERMANENT KEYED CORE
 10" CTC X 1.75"+ 0.5"
3 IVES OFFSET PULL 630
3 GLYNN JOHNSON CONC OH STOP 36" 630
3 LCN SURFACE CLOSER 689
3 LCN DROP PLATE 689
NOTE: CORRECTED DROP PLATE FOR SPECIFIED CLOSER WHICH CANNOT BE TOP JAMB MOUNTED. ADVISE
3 LCN CUSH SUPPORT 689
3 LCN BLADE STOP SPACER 689
3 ZERO DRIP CAP 40" CLR
3 DOOR MFG MFG STD WEATHERING
3 ZERO DOOR SWEEP/DRIP 36" CLR
3 DOOR MFG THRESHOLD
3 SCHLAGE ELEC SE DOOR POSITION SWITCH
HW SET 2.100 ARCHSET 2
1 DOOR#: 1600A
DOOR SIZE: 36" X 96" X 1.75"+0.5"
DOOR TYPE: (1) SINGLE MEDIUM STILE
THERMAL ALUMINUM
DOOR DESC: 350T
TOTAL MATERIAL REQUIRED FOR THE ABOVE HARDWARE SET:
1 IVES CONTINUOUS HINGE 95" 628
1 VON DUPRIN POWER TRANSFER SP28
1 VON DUPRIN RIM EXIT 36" X 1.75"+0.5" 626
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1 SCHLAGE FSIC RIM CYLINDER 626
   1 SCHLAGE CONTROL KEY
   1 BY OTHERS PERMANENT KEYED CORE
   10" CTC X 1.75"+ 0.5"
   1 IVES OFFSET PULL 630
   1 GLYNN JOHNSON CONC OH STOP 36" 630
   1 LCN SURFACE CLOSER 689
   1 LCN DROP PLATE 689
   NOTE: CORRECTED DROP PLATE FOR SPECIFIED CLOSER WHICH CANNOT BE TOP JAMB MOUNTED. ADVISE
   1 LCN CUSH SUPPORT 689
   1 LCN BLADE STOP SPACER 689
  1 ZERO DRIP CAP 40" CLR
  1 DOOR MFG MFG STD WEATHERING
  1 ZERO DOOR SWEEP/DRIP 36" CLR
  1 DOOR MFG THRESHOLD
  1 SCHLAGE ELEC SE DOOR POSITION SWITCH
  HW SET 3.000 ARCHSET 3
                                     CM STAY AS Medium Style doors if Required
  1 DOOR#: 2085A
  DOOR SIZE: 36" X 94" X 1.75"+0.5"
  DOOR TYPE: (1) SINGLE MEDIUM STILE
  THERMAL ALUMINUM
  DOOR DESC: 350T
  TOTAL MATERIAL REQUIRED FOR THE ABOVE HARDWARE SET:
  1 IVES CONTINUOUS HINGE 93" 628
  1 VON DUPRIN POWER TRANSFER SP28
  1 VON DUPRIN ALARMED RIM EXIT 36" X 1,75"+0.5" 626
  1 SCHLAGE FSIC RIM CYLINDER 626
  1 SCHLAGE FSIC MORT CYLINDER 626
 1 SCHLAGE CONTROL KEY
 2 BY OTHERS PERMANENT KEYED CORE
 10" CTC X 1.75"+ 0.5"
 1 IVES OFFSET PULL 630
 1 GLYNN JOHNSON CONC OH STOP 36" 630
 1 LCN SURFACE CLOSER 689
 1 LCN DROP PLATE 689
 NOTE: CORRECTED DROP PLATE FOR SPECIFIED CLOSER WHICH CANNOT BE TOP JAMB MOUNTED. ADVISE
 1 LCN CUSH SUPPORT 689
 1 LCN BLADE STOP SPACER 689
 1 ZERO DRIP CAP 40" CLR
 1 DOOR MFG MFG STD WEATHERING
 1 ZERO DOOR SWEEP/DRIP 36" CLR
 1 DOOR MFG THRESHOLD
 1 SCHLAGE ELEC SE DOOR POSITION SWITCH
 1 BY OTHERS BY SECURITY
 1 VON DUPRIN POWER SUPPLY
 1 SPG ENGINEERIN CUSTOM DIAGRAM
 1 SPG ENGINEERIN POINT TO POINT
 HW SET 4,000 ARCHSET 4
 1 DOOR#: 2710A
 1 DOOR#: 2718A
 1 DOOR#: 2720A
1 DOOR#: 2910A
                                  reeds To Change To wide STyle due To hundware
1 DOOR#: 2902A
DOOR SIZE: 36" X 96" X 1.75"+0.5"
DOOR TYPE: (5) SINGLE WIDE STILE
THERMAL ALUMINUM
DOOR DESC: 500T
NOTE: WIDE STILE REQUIRED
TOTAL MATERIAL REQUIRED FOR THE ABOVE HARDWARE SET:
5 IVES CONTINUOUS HINGE 95" 628
5 SCHLAGE MORT STOREROOM LOCK 1.75"+0.5" 630
NOTE: WIDE STILE REQUIRED
1 SCHLAGE CONTROL KEY
10 BY OTHERS PERMANENT KEYED CORE
5 GLYNN JOHNSON CONC OH STOP 36" 630
5 LCN SURFACE CLOSER 689
5 LCN DROP PLATE 689
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5 IVES KICK PLATE 630 5 ZERO DOOR SWEEP/DRIP 36" CLR 5 DOOR MFG THRESHOLD 5 SCHLAGE ELEC SE DOOR POSITION SWITCH **HW SET 4.1 ARCHSET 4** 1 DOOR#: 2918A weeds to change to wide style down Because of specified handwarp 1 DOOR#: 2928A DOOR SIZE: 36" X 94" X 1.75"+0.5" DOOR TYPE: (2) SINGLE WIDE STILE THERMAL ALUMINUM DOOR DESC: 500T NOTE: WIDE STILE REQUIRED TOTAL MATERIAL REQUIRED FOR THE ABOVE HARDWARE SET: 2 IVES CONTINUOUS HINGE 93" 628 2 SCHLAGE MORT STOREROOM LOCK 1.75"+0.5" 630 NOTE: WIDE STILE REQUIRED 1 SCHLAGE CONTROL KEY 4 BY OTHERS PERMANENT KEYED CORE 2 GLYNN JOHNSON CONC OH STOP 36" 630 2 LCN SURFACE CLOSER 689 2 LCN DROP PLATE 689 2 IVES KICK PLATE 630 2 ZERO DOOR SWEEP/DRIP 36" CLR 2 DOOR MFG THRESHOLD 2 SCHLAGE ELEC SE DOOR POSITION SWITCH HW SET 5.000 ARCHSET 7 1 DOOR#: 1680A Needs To Change To wide STyle doors Because of Specified handware DOOR SIZE: 96" X 96" X 1.75"+0.5" DOOR TYPE: (1) PAIR WIDE STILE THERMAL ALUMINUM DOOR DESC: 500T NOTE: WIDE STILE REQUIRED TOTAL MATERIAL REQUIRED FOR THE ABOVE HARDWARE SET: 2 IVES CONTINUOUS HINGE 95" 628 1 VON DUPRIN KEY REM MULLION 7'-6" SP28 NOTE: MULLION / EXIT COMBINATION REQUIRES WIDE STILE 1 VON DUPRIN RIM EXIT 48" X 1.75"+0.5" 626 1 VON DUPRIN RIM EXIT 48" X 1.75"+0.5" 628 1 SCHLAGE FSIC RIM CYLINDER 626 1 SCHLAGE FSIC MORT CYLINDER 626 FOR MULLION 2 SCHLAGE FSIC MORTISE CYLINDER 626 FOR CYLINDER DOGGING 1 SCHLAGE CONTROL KEY 3 BY OTHERS PERMANENT KEYED CORE 48" O.A. X 42" CTC X 1.75"+0.5" 2 ROCKWOOD OFFSET PULL 630 2 GLYNN JOHNSON CONC OH STOP 48" 630 2 LCN SURFACE CLOSER 689 2 LCN DROP PLATE 689 NOTE: CORRECTED DROP PLATE FOR SPECIFIED CLOSER WHICH CANNOT BE TOP JAMB MOUNTED. ADVISE 2 LCN BLADE STOP SPACER 689 1 ZERO DRIP CAP 100" CLR 1 DOOR MFG MFG STD WEATHERING 2 ZERO DOOR SWEEP/DRIP 48" CLR 1 DOOR MFG THRESHOLD 2 SCHLAGE ELEC SE DOOR POSITION SWITCH HW SET 5.100 ARCHSET 7 MOD. 1 DOOR#: 2535A CAN STRY AS Medium Style doors if Required 1 DOOR#: 2535B DOOR SIZE: 36" X 94" X 1.75"+0.5" DOOR TYPE: (2) SINGLE MEDIUM STILE THERMAL ALUMINUM DOOR DESC: 350T

THIS HOW SET HAS BEEN MODIFIED FOR A SINGLE DOOR LEAF.

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TOTAL MATERIAL REQUIRED FOR THE ABOVE HARDWARE SET:
  2 IVES CONTINUOUS HINGE 93" 628
  2 VON DUPRIN RIM EXIT 36" X 1.75"+0.5" 628
  2 SCHLAGE FSIC RIM CYLINDER 626
  2 SCHLAGE FSIC MORTISE CYLINDER 626
  1 SCHLAGE CONTROL KEY
  2 BY OTHERS PERMANENT KEYED CORE
 48" O.A. X 42" CTC
 X 1.75"+0.5"
 2 ROCKWOOD OFFSET PULL 630
 2 GLYNN JOHNSON CONC OH STOP 36" 630
 2 LCN SURFACE CLOSER 689
 2 LCN DROP PLATE 689
 NOTE: CORRECTED DROP PLATE FOR SPECIFIED CLOSER WHICH CANNOT BE TOP JAMB MOUNTED, ADVISE
 2 LCN BLADE STOP SPACER 689
 2 ZERO DRIP CAP 40" CLR
 2 DOOR MFG MFG STD WEATHERING
 2 ZERO DOOR SWEEP/DRIP 36" CLR
 2 DOOR MFG THRESHOLD
 2 SCHLAGE ELEC SE DOOR POSITION SWITCH
 HW SET 6.000 ARCHSET 8
 1 DOOR#: 1001A
                                            STAY as medium style doves if Required
 1 DOOR#: 1050A
 DOOR SIZE: 72" X 94" X 1.75"+0.5"
 DOOR TYPE: (2) PAIR MEDIUM STILE
 THERMAL ALUMINUM
 DOOR DESC: 350T
 TOTAL MATERIAL REQUIRED FOR THE ABOVE HARDWARE SET:
 4 IVES CONTINUOUS HINGE 93" 628
 4 VON DUPRIN POWER TRANSFER SP28
 2 VON DUPRIN KEY REM MULLION 8'-6" SP28
 2 VON DUPRIN ELEC RIM EXIT 36" X 1.75"+0.5" 626
 2 VON DUPRIN ELEC RIM EXIT 36" X 1.75"+0.5" 626
 2 SCHLAGE FSIC RIM CYLINDER 626
 2 SCHLAGE FSIC MORT CYLINDER 626
 1 SCHLAGE CONTROL KEY
 4 BY OTHERS PERMANENT KEYED CORE
48" O.A. X 42" CTC X 1.75"+0.5"
4 ROCKWOOD OFFSET PULL 630
4 GLYNN JOHNSON CONC OH STOP 36" 630
4 LCN SURFACE CLOSER 689
4 LCN DROP PLATE 689
NOTE: CORRECTED DROP PLATE FOR SPECIFIED CLOSER WHICH CANNOT BE TOP JAMB MOUNTED. ADVISE
4 LCN BLADE STOP SPACER 689
2 ZERO DRIP CAP 76" CLR
2 DOOR MFG MFG STD WEATHERING
4 ZERO DOOR SWEEP/DRIP 36" CLR
2 DOOR MFG THRESHOLD
4 SCHLAGE ELEC SE DOOR POSITION SWITCH
2 BY OTHERS BY SECURITY
2 VON DUPRIN POWER SUPPLY
HW SET 7.000 ARCHSET 9
1 DOOR#: 1001D
1 DOOR#: 1050D
                                            STAY as medium style dours if Required
DOOR SIZE: 36" X 94" X 1,75"+0.5"
DOOR TYPE: (2) SINGLE MEDIUM STILE
THERMAL ALUMINUM
DOOR DESC: 350T
TOTAL MATERIAL REQUIRED FOR THE ABOVE HARDWARE SET:
2 IVES CONTINUOUS HINGE 93" 628
2 VON DUPRIN POWER TRANSFER SP28
2 VON DUPRIN ELEC RIM EXIT 36" X 1.75"+0.5" 626
2 SCHLAGE FSIC RIM CYLINDER 626
1 SCHLAGE CONTROL KEY
2 BY OTHERS PERMANENT KEYED CORE
48" O.A. X 42" CTC X 1.75"+0.5"
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2 ROCKWOOD OFFSET PULL 630 2 GLYNN JOHNSON CONC OH STOP 36" 630 2 LCN SURFACE OPERATOR 689 NOTE: THE 4642 OPERATOR IS INTENDED FOR OCCASIONAL ELECTRIC ACTIVATION, IF THIS IS A HIGH TRAFFIC DOOR, WE RECOMMEND USING THE 9500 SERIES ELECTROMECHANICAL SENIOR SWING. NOTE TO BE FLUSH CEILING MTD. FOR USE IN CONJUNCTION WITH O.H. STOP 2 LCN WALL ACTUATOR 2 SCHLAGE ELEC SE DOOR POSITION SWITCH 2 BY OTHERS BY SECURITY 2 VON DUPRIN POWER SUPPLY 1 SPG ENGINEERIN CUSTOM DIAGRAM 1 SPG ENGINEERIN POINT TO POINT HW SET 8.000 ARCHSET 11 1 DOOR#: 1001C 1 DOOR#: 1050C weeds to Change To Wide Style down Because of handware DOOR TYPE: (2) PAIR WIDE STILE THERMAL ALUMINUM

DOOR DESC: 500T DOOR DESC: 500T NOTE: WIDE STILE REQUIRED TOTAL MATERIAL REQUIRED FOR THE ABOVE HARDWARE SET: 4 IVES CONTINUOUS HINGE 93" 628 4 VON DUPRIN POWER TRANSFER SP28 2 VON DUPRIN KEY REM MULLION 8'-6" SP28 NOTE: MULLION / EXIT COMBINATION REQUIRES WIDE STILE 2 VON DUPRIN ELEC RIM EXIT 36" X 1.75"+0.5" 626 2 VON DUPRIN ELEC RIM EXIT 36" X 1.75"+0.5" 626 2 SCHLAGE FSIC RIM CYLINDER 626 2 SCHLAGE FSIC MORT CYLINDER 626 1 SCHLAGE CONTROL KEY 4 BY OTHERS PERMANENT KEYED CORE 48" O.A. X 42" CTC X 1.75"+0.5" 4 ROCKWOOD OFFSET PULL 630 4 GLYNN JOHNSON CONC OH STOP 36" 630 4 LCN SURFACE CLOSER 689 4 LCN DROP PLATE 689 NOTE: CORRECTED DROP PLATE FOR SPECIFIED CLOSER WHICH CANNOT BE TOP JAMB MOUNTED. ADVISE 4 LCN BLADE STOP SPACER 689 2 DOOR MFG MFG STD WEATHERING 2 DOOR MFG THRESHOLD 4 SCHLAGE ELEC SE DOOR POSITION SWITCH 2 BY OTHERS BY SECURITY 2 VON DUPRIN POWER SUPPLY HW SET 9.000 ARCHSET 12 CAN STAY AS Medium STyle down if Regulared 1 DOOR#: 2085 DOOR SIZE: 36" X 94" X 1.75"+0.5" DOOR TYPE: (1) SINGLE MEDIUM STILE THERMAL ALUMINUM DOOR DESC: 350T TOTAL MATERIAL REQUIRED FOR THE ABOVE HARDWARE SET: 1 IVES CONTINUOUS HINGE 93" 628 1 VON DUPRIN RIM EXIT W/ LEVER 36" X 1.75"+0.5" 626 1 SCHLAGE FSIC RIM CYLINDER 626 1 SCHLAGE FSIC MORT CYLINDER 626 1 SCHLAGE CONTROL KEY 1 BY OTHERS PERMANENT KEYED CORE 1 GLYNN JOHNSON CONC OH STOP 36" 630 1 LCN SURFACE CLOSER 689 1 LCN DROP PLATE 689 NOTE: CORRECTED DROP PLATE FOR SPECIFIED CLOSER WHICH CANNOT BE TOP JAMB MOUNTED. ADVISE 1 LCN BLADE STOP SPACER 689 1 DOOR MFG MFG STD WEATHERING HW SET 10.000 ARCHSET 16 1 DOOR#: 1040A 1 DOOR#: 1328A

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1 DOOR#: 2070A

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DOOR SIZE: 36" X 94" X 1.75"+0.5"

DOOR TYPE: (3) SINGLE MEDIUM STILE

THERMAL ALUMINUM DOOR DESC: 350T

TOTAL MATERIAL REQUIRED FOR THE ABOVE HARDWARE SET:

3 IVES CONTINUOUS HINGE 93" 628 3 VON DUPRIN POWER TRANSFER SP28 3 VON DUPRIN RIM EXIT 36" X 1.75"+0.5" 626 3 GLYNN JOHNSON CONC OH STOP 36" 630

3 LCN SURFACE CLOSER 689

3 LCN DROP PLATE 689

NOTE: CORRECTED DROP PLATE FOR SPECIFIED CLOSER WHICH CANNOT BE TOP JAMB MOUNTED. ADVISE

3 LCN BLADE STOP SPACER 689 3 ZERO DRIP CAP 40" CLR 3 DOOR MFG MFG STD WEATHERING 3 ZERO DOOR SWEEP/DRIP 36" CLR 3 DOOR MFG THRESHOLD

3 SCHLAGE ELEC SE DOOR POSITION SWITCH

Total Base Bid:

\$USD

Freight: Prepaid, FOB Factory

# **Terms and Conditions**

Note, the prices contained in this estimate are valid for 30 days, and if accepted, are still subject to an inflation add if the materials are not shipped within 6 months from time of estimate.

The products on this Material Proposal are warranted for a period of 2 years

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DOOR #:			QUANTITY:				
ARCHITECT'S DOOR #:	1001		DOOR OPENING:	6'-0"x 7'-10"			
LOCATION:	SF #S06	Entry Vestibule	LEAVES:	Pair	<u>&gt;</u>		l _ l
MANUFACTURER:	Kawneer		SWING:	Outswing	dc	Q	tal
DOOR TYPE:	Insulpour	500T Thermal 2 1/4" doors	DOOR FINISH:	TBD	Supply	Prep	Install
FRAMING SYSTEM HEAD:	601UT sto	prefronts	ARCH. HW. SET:	8	,	Ψ.	-
FRAMING SYSTEM JAMB:	601UT St	orefronts			У	¥	¥
HARDWARE	QTY/LEAF	MANUFACTURER/DESCRIPTION	FINISH	NOTES/DIMENSIONS			
CONT HINGES	1	Ives 112HD-EPT	630				
OVERHEAD STOP	1	GLY 100S	630	Concealed heavy duty			
ACTIVE LEAF EXIT DEVICE	1	Von Duprin RX-QEL 35A-EO	US26D	1/2" INS Kit			
IN-ACTIVE LEAF EXIT DEVICE	1	Von Duprin RX-QEL 35A-NL-OP	US26D	1/2" INS Kit			
RIM CYLINDER	1	Schlage, 7 Pin SFIC (as required)	626				
MORTISE CYLINDER	1	Schlage, 7 Pin SFIC (as required)	626				
REMOVABLE MULLION	1	VON DUPRIN KR4954	626				
OFFSET PULLS	1	ROCKWOOD RM3310x48"	630				
CLOSER	1	LCN 4040XP EDA	689				
CLOSER DROP PLATES	1	LCN 4040XP-18G	689				
DRIP CAP	1	Zero 142	626				
THRESHOLD	1	Kawneer Standard		By kawneer			
WEATHERSTRIPPING	1	Kawneer Standard		By kawneer			
DOOR SWEEPS	1	Zero 8198AA	626				
DOOR CONTACTS	1	Sce 679-05HM/WD		BY OTHERS			
CARD READER		BY OTHERS		BY OTHERS			
POWER SUPPLY	1	Von Duprin PS902 900-2RS		BY OTHERS			
POWER TRANSFERS	1	Von Duprin EPT 10 CON	689				

- 1. COORDINATION OF ACCESS CONTROL, ELECTRIC HARDWARE AND SECURITY SYSTEM BY OTHERS.
- \* FROM BOTTOM OF DOOR TO CENTERLINE OF TOP ATTACHMENT
- \*\* FROM BOTTOM OF DOOR TO CENTERLINE OF PUSH BAR
- \*\*\* FROM BOTTOM OF DOOR TO CENTERLINE CYLINDER

DOOR #:	1001B		QUANTITY:	1			
ARCHITECT'S DOOR #:	1001		DOOR OPENING:				
LOCATION:	SF #S06	Entry Vestibule	LEAVES:	Single	>		_
MANUFACTURER:	Kawneer		SWING:	Outswing	Supply	d	Install
DOOR TYPE:	Insulpour	500T Thermal 2 1/4" doors	DOOR FINISH:	TBD	ıμί	Prep	JSI
FRAMING SYSTEM HEAD:			ARCH. HW. SET:	1	9	- F	=
FRAMING SYSTEM JAMB:	601UT St	orefronts			¥	¥	¥
HARDWARE	QTY/LEAF	MANUFACTURER/DESCRIPTION	FINISH	NOTES/DIMENSIONS			
CONT HINGES	1	Ives 112HD-EPT	630				
OVERHEAD STOP	1	GLY 100S	630	Concealed heavy duty			
ACTIVE LEAF EXIT DEVICE	1	Von Duprin RX-QEL 35A-NL-OP	626	1/2" INS Kit			
RIM CYLINDER		Schlage, 7 Pin SFIC (as required)	626				
OFFSET PULLS	1	Rockwood RM3310 x 48	630				
AUTO OPERATOR	1	LCN 4640 (push side)	689				
WALL ACTUATOR	1	LCN 8310-818T	630				
WALL ACTUATOR	1	LCN 8310-855 (Vestibule)	630				
DRIP CAP	1	Zero 142	626				
THRESHOLD	1	Kawneer Standard		By kawneer			
WEATHERSTRIPPING	1	Kawneer Standard		By kawneer			
DOOR SWEEPS	1	Zero 8198AA	626				
DOOR CONTACTS	1	Sce 679-05HM/WD		BY OTHERS			
POWER SUPPLY	1	Von Duprin PS902 900-2RS		BY OTHERS			
POWER TRANSFERS	1	Von Duprin EPT 10 CON	689				

- 1. COORDINATION OF ACCESS CONTROL, ELECTRIC HARDWARE AND SECURITY SYSTEM BY OTHERS.
- \* FROM BOTTOM OF DOOR TO CENTERLINE OF TOP ATTACHMENT
- \*\* FROM BOTTOM OF DOOR TO CENTERLINE OF PUSH BAR
- \*\*\* FROM BOTTOM OF DOOR TO CENTERLINE CYLINDER

					_
DOOR #:	1001C	QUANTITY:	1		

ARCHITECT'S DOOR #:	1001		DOOR OPENING:	6'-0"x 7'-10"			
LOCATION:	SF #S08	Entry Vestibule	LEAVES:	Pair	>	i	۱_
MANUFACTURER:	Kawneer		SWING:	Outswing	Supply	۵	Install
DOOR TYPE:	Insulpour	500T Thermal 2 1/4" doors	DOOR FINISH:	TBD	μ	Prep	lst
FRAMING SYSTEM HEAD:	601UT sto	orefronts	ARCH. HW. SET:	11	S	1 -	₹
FRAMING SYSTEM JAMB:	601UT St	orefronts			Y	Y	¥
HARDWARE	QTY/LEAF	MANUFACTURER/DESCRIPTION	FINISH	NOTES/DIMENSIONS			
CONT HINGES	1	Ives 112HD-EPT	630				
OVERHEAD STOP	1	GLY 100S	630	Concealed heavy duty			
ACTIVE LEAF EXIT DEVICE	1	Von Duprin RX-QEL 35A-EO	US26D	1/2" INS Kit			
IN-ACTIVE LEAF EXIT DEVICE	1	Von Duprin RX-QEL 35A-NL-OP	US26D	1/2" INS Kit			
RIM CYLINDER	1	Schlage, 7 Pin SFIC (as required)	626				
MORTISE CYLINDER	1	Schlage, 7 Pin SFIC (as required)	626				
REMOVABLE MULLION	1	VON DUPRIN KR4954	626				
OFFSET PULLS	1	ROCKWOOD RM3310x48"	630				
CLOSER	1	LCN 4040XP EDA	689				
CLOSER DROP PLATES	1	LCN 4040XP-18G	689				
WEATHERSTRIPPING	1	Kawneer Standard	N/A	By kawneer			
DOOR CONTACTS	1	Sce 679-05HM/WD		BY OTHERS			
CARD READER		BY OTHERS		BY OTHERS			
POWER SUPPLY	1	Von Duprin PS902 900-2RS		BY OTHERS			
POWER TRANSFERS	1	Von Duprin EPT 10 CON	689				

- 1. COORDINATION OF ACCESS CONTROL, ELECTRIC HARDWARE AND SECURITY SYSTEM BY OTHERS.
- \* FROM BOTTOM OF DOOR TO CENTERLINE OF TOP ATTACHMENT
- \*\* FROM BOTTOM OF DOOR TO CENTERLINE OF PUSH BAR
- \*\*\* FROM BOTTOM OF DOOR TO CENTERLINE CYLINDER

DOOR #:	1001D		QUANTITY:	1			
ARCHITECT'S DOOR #:	1001		DOOR OPENING:	3'-0"- 7'-10"			
LOCATION:	SF #S08	Entry Vestibule	LEAVES:	Single	Λ		l_
MANUFACTURER:	Kawneer		SWING:	Outswing	Supply	d	Install
DOOR TYPE:	Insulpour	500T Thermal 2 1/4" doors	DOOR FINISH:	TBD	juk	Prep	)St
FRAMING SYSTEM HEAD:	601UT sto	orefronts	ARCH. HW. SET:	9	י	4	=
FRAMING SYSTEM JAMB:	601UT St	orefronts			Y	¥	¥
HARDWARE	QTY/LEAF	MANUFACTURER/DESCRIPTION	FINISH	NOTES/DIMENSIONS			
CONT HINGES	1	Ives 112HD-EPT	630				
OVERHEAD STOP	1	GLY 100S	630	Concealed heavy duty			
ACTIVE LEAF EXIT DEVICE	1	Von Duprin RX-QEL 35A-NL-OP	626	1/2" INS Kit			
RIM CYLINDER		Schlage, 7 Pin SFIC (as required)	626				
OFFSET PULLS	1	Rockwood RM3310 x 48	630				
AUTO OPERATOR	1	LCN 4640 (push side)	689				
WALL ACTUATOR	1	LCN 8310-818T	630				
WEATHERSTRIPPING	1	Kawneer Standard	N/A	By kawneer			
DOOR CONTACTS	1	Sce 679-05HM/WD		BY OTHERS			
CARD READER		BY OTHERS		BY OTHERS			
POWER SUPPLY	1	Von Duprin PS902 900-2RS		BY OTHERS			
POWER TRANSFERS	1	Von Duprin EPT 10 CON	689				

- 1. COORDINATION OF ACCESS CONTROL, ELECTRIC HARDWARE AND SECURITY SYSTEM BY OTHERS.
- \* FROM BOTTOM OF DOOR TO CENTERLINE OF TOP ATTACHMENT
- \*\* FROM BOTTOM OF DOOR TO CENTERLINE OF PUSH BAR
- \*\*\* FROM BOTTOM OF DOOR TO CENTERLINE CYLINDER

DOOR #:	1040A	QUANTITY:	1			
ARCHITECT'S DOOR #:	1040	DOOR OPENING:	3'-0"x 7'-10"			
LOCATION:	SF #W45 STAIR 4	LEAVES:	Single	<u>&gt;</u>		l _ I
MANUFACTURER:	Kawneer	SWING:	outswing	ldd	۵	ta
DOOR TYPE:	Insulpour 500T Thermal 2 1/4" doors	DOOR FINISH:	TBD	֓֞֟֞֞֞֞֞֞֞֞֞֞֞֓֓֞֞֞֞֞֞֞֡֡֓֞֡֡֞֞֡֡֡֡֡֡֡֡֡	<sup>2</sup> re	nSi

FRAMING SYSTEM HEAD:	601UT sto	prefronts	ARCH. HW. SET:	16	י	-	-
FRAMING SYSTEM JAMB:	601UT St	orefronts			X	Y	メ
HARDWARE	QTY/LEAF	MANUFACTURER/DESCRIPTION	FINISH	NOTES/DIMENSIONS			
CONT HINGES	1	Ives 112HD-EPT	630				
OVERHEAD STOP	1	GLY 100S	630	Concealed heavy duty			
ACTIVE LEAF EXIT DEVICE	1	Von Duprin RX 35A-EO	626	1/2" INS Kit			
CLOSER	1	LCN 4040XP EDA	689				
CLOSER DROP PLATES	1	LCN 4040XP-18G	689				
DRIP CAP	1	Zero 142	626				
THRESHOLD	1	Kawneer Standard		By kawneer			
WEATHERSTRIPPING	1	Kawneer Standard		By kawneer			
DOOR SWEEPS	1	Zero 8198AA	626				
DOOR CONTACTS	1	Sce 679-05HM/WD		BY OTHERS			
POWER TRANSFERS	1	Von Duprin EPT 10 CON	689				

- 1. COORDINATION OF ACCESS CONTROL, ELECTRIC HARDWARE AND SECURITY SYSTEM BY OTHERS.
- \* FROM BOTTOM OF DOOR TO CENTERLINE OF TOP ATTACHMENT
- \*\* FROM BOTTOM OF DOOR TO CENTERLINE OF PUSH BAR
- \*\*\* FROM BOTTOM OF DOOR TO CENTERLINE CYLINDER

					_		
DOOR #:			QUANTITY:	1			
ARCHITECT'S DOOR #:	1050		DOOR OPENING:	6'-0"x 7'-10"			
LOCATION:	SF # LOE	BBY	LEAVES:		<u>&gt;</u>		l _
MANUFACTURER:	Kawneer		SWING:	Outswing	dc	a	ta
DOOR TYPE:	Insulpour	500T Thermal 2 1/4" doors	DOOR FINISH:	TBD	Supply	Prep	Install
FRAMING SYSTEM HEAD:	601UT sto	prefronts	ARCH. HW. SET:	8	'	Ψ.	-
FRAMING SYSTEM JAMB:	601UT St	orefronts			¥	X	¥
HARDWARE	QTY/LEAF	MANUFACTURER/DESCRIPTION	FINISH	NOTES/DIMENSIONS			
CONT HINGES	1	Ives 112HD-EPT	630				
OVERHEAD STOP	1	GLY 100S	630	Concealed heavy duty			
ACTIVE LEAF EXIT DEVICE	1	Von Duprin RX-QEL 35A-EO	US26D	1/2" INS Kit			
IN-ACTIVE LEAF EXIT DEVICE	1	Von Duprin RX-QEL 35A-NL-OP	US26D	1/2" INS Kit			
RIM CYLINDER	1	Schlage, 7 Pin SFIC (as required)	626				
MORTISE CYLINDER	1	Schlage, 7 Pin SFIC (as required)	626				
REMOVABLE MULLION	1	VON DUPRIN KR4954	626				
OFFSET PULLS	1	ROCKWOOD RM3310x48"	630				
CLOSER	1	LCN 4040XP EDA	689				
CLOSER DROP PLATES	1	LCN 4040XP-18G	689				
DRIP CAP	1	Zero 142	626				
THRESHOLD	1	Kawneer Standard		By kawneer			
WEATHERSTRIPPING	1	Kawneer Standard		By kawneer			
DOOR SWEEPS	1	Zero 8198AA	626				
DOOR CONTACTS	1	Sce 679-05HM/WD		BY OTHERS			
CARD READER		BY OTHERS		BY OTHERS			
POWER SUPPLY	1	Von Duprin PS902 900-2RS		BY OTHERS			
POWER TRANSFERS	1	Von Duprin EPT 10 CON	689				

- 1. COORDINATION OF ACCESS CONTROL, ELECTRIC HARDWARE AND SECURITY SYSTEM BY OTHERS.
- \* FROM BOTTOM OF DOOR TO CENTERLINE OF TOP ATTACHMENT
- \*\* FROM BOTTOM OF DOOR TO CENTERLINE OF PUSH BAR
- \*\*\* FROM BOTTOM OF DOOR TO CENTERLINE CYLINDER

DOOR #:	1050B	QUANTITY:	1			
ARCHITECT'S DOOR #:	1050	DOOR OPENING:	3'-0"- 7'-10"			
LOCATION:	SF # LOBBY	LEAVES:	Single	<u>&gt;</u>		I _ I
MANUFACTURER:	Kawneer	SWING:	Outswing	Q.I	d	폡
DOOR TYPE:	Insulpour 500T Thermal 2 1/4" doors	DOOR FINISH:	TBD	Supl	Pre	nSi
FRAMING SYSTEM HEAD:	601UT storefronts	ARCH. HW. SET:	1	יט	- F	<u> </u>
FRAMING SYSTEM JAMB:	601UT Storefronts			¥	У	¥

HARDWARE	QTY/LEAF	MANUFACTURER/DESCRIPTION	FINISH	NOTES/DIMENSIONS	
CONT HINGES	1	Ives 112HD-EPT	630		
OVERHEAD STOP	1	GLY 100S	630	Concealed heavy duty	
ACTIVE LEAF EXIT DEVICE	1	Von Duprin RX-QEL 35A-NL-OP	626	1/2" INS Kit	
RIM CYLINDER		Schlage, 7 Pin SFIC (as required)	626		
OFFSET PULLS	1	Rockwood RM3310 x 48	630		
AUTO OPERATOR	1	LCN 4640 (push side)	689		
WALL ACTUATOR	1	LCN 8310-818T	630		
WALL ACTUATOR	1	LCN 8310-855 (Vestibule)	630		
DRIP CAP	1	Zero 142	626		
THRESHOLD	1	Kawneer Standard		By kawneer	
WEATHERSTRIPPING	1	Kawneer Standard		By kawneer	
DOOR SWEEPS	1	Zero 8198AA	626		
DOOR CONTACTS	1	Sce 679-05HM/WD		BY OTHERS	
POWER SUPPLY	1	Von Duprin PS902 900-2RS		BY OTHERS	
POWER TRANSFERS	1	Von Duprin EPT 10 CON	689		

- 1. COORDINATION OF ACCESS CONTROL, ELECTRIC HARDWARE AND SECURITY SYSTEM BY OTHERS.
- \* FROM BOTTOM OF DOOR TO CENTERLINE OF TOP ATTACHMENT
- \*\* FROM BOTTOM OF DOOR TO CENTERLINE OF PUSH BAR
- \*\*\* FROM BOTTOM OF DOOR TO CENTERLINE CYLINDER

DOOR #:	1050C		QUANTITY:	1			
ARCHITECT'S DOOR #:			DOOR OPENING:				
LOCATION:		LOBBY	LEAVES:		_		
MANUFACTURER:				Outswing	Supply	٥	Install
		500T Thermal 2 1/4" doors	DOOR FINISH:		dn	Prep	ıst
FRAMING SYSTEM HEAD:			ARCH. HW. SET:	11	S.	٠.	<del>-</del>
FRAMING SYSTEM JAMB:	601UT St	orefronts			¥	¥	<b>×</b>
HARDWARE	QTY/LEAF	MANUFACTURER/DESCRIPTION	FINISH	NOTES/DIMENSIONS			
CONT HINGES	1	Ives 112HD-EPT	630				
OVERHEAD STOP	1	GLY 100S	630	Concealed heavy duty			
ACTIVE LEAF EXIT DEVICE	1	Von Duprin RX-QEL 35A-EO	US26D	1/2" INS Kit			
IN-ACTIVE LEAF EXIT DEVICE	1	Von Duprin RX-QEL 35A-NL-OP	US26D	1/2" INS Kit			
RIM CYLINDER	1	Schlage, 7 Pin SFIC (as required)	626				
MORTISE CYLINDER	1	Schlage, 7 Pin SFIC (as required)	626				
REMOVABLE MULLION	1	VON DUPRIN KR4954	626				
OFFSET PULLS	1	ROCKWOOD RM3310x48"	630				
CLOSER	1	LCN 4040XP EDA	689				
CLOSER DROP PLATES	1	LCN 4040XP-18G	689				
WEATHERSTRIPPING	1	Kawneer Standard	N/A	By kawneer			
DOOR CONTACTS	1	Sce 679-05HM/WD		BY OTHERS			
CARD READER		BY OTHERS		BY OTHERS			
POWER SUPPLY	1	Von Duprin PS902 900-2RS		BY OTHERS			
POWER TRANSFERS	1	Von Duprin EPT 10 CON	689				

- 1. COORDINATION OF ACCESS CONTROL, ELECTRIC HARDWARE AND SECURITY SYSTEM BY OTHERS.
- \* FROM BOTTOM OF DOOR TO CENTERLINE OF TOP ATTACHMENT
- \*\* FROM BOTTOM OF DOOR TO CENTERLINE OF PUSH BAR
- \*\*\* FROM BOTTOM OF DOOR TO CENTERLINE CYLINDER

HARDWARE	QTY/LEAF MANUFACTURER/DESCRIPTION	FINISH	NOTES/DIMENSIONS			
FRAMING SYSTEM JAMB:	601UT Storefronts			¥	¥	¥
FRAMING SYSTEM HEAD:	601UT storefronts	ARCH. HW. SET:	9	5	ь.	- I
DOOR TYPE:	Insulpour 500T Thermal 2 1/4" doors	DOOR FINISH:	TBD	Supp	re	ns
MANUFACTURER:	Kawneer	SWING:	Outswing		ď	tal
LOCATION:	SF #W15 LOBBY	LEAVES:	Single	<u>&gt;</u>		_
ARCHITECT'S DOOR #:	1050	DOOR OPENING:	3'-0"- 7'-10 15/16"			
DOOR #:	1050D	QUANTITY:	1			

CONT HINGES	1	Ives 112HD-EPT	630			
OVERHEAD STOP	1	GLY 100S	630	Concealed heavy duty		
ACTIVE LEAF EXIT DEVICE	1	Von Duprin RX-QEL 35A-NL-OP	626	1/2" INS Kit		
RIM CYLINDER		Schlage, 7 Pin SFIC (as required)	626			
OFFSET PULLS	1	Rockwood RM3310 x 48	630			
AUTO OPERATOR	1	LCN 4640 (push side)	689			
WALL ACTUATOR	1	LCN 8310-818T	630			
WEATHERSTRIPPING	1	Kawneer Standard	N/A	By kawneer		
DOOR CONTACTS	1	Sce 679-05HM/WD		BY OTHERS		
CARD READER		BY OTHERS		BY OTHERS		
POWER SUPPLY	1	Von Duprin PS902 900-2RS		BY OTHERS		
POWER TRANSFERS	1	Von Duprin EPT 10 CON	689			

- 1. COORDINATION OF ACCESS CONTROL, ELECTRIC HARDWARE AND SECURITY SYSTEM BY OTHERS.
- \* FROM BOTTOM OF DOOR TO CENTERLINE OF TOP ATTACHMENT
- \*\* FROM BOTTOM OF DOOR TO CENTERLINE OF PUSH BAR
- \*\*\* FROM BOTTOM OF DOOR TO CENTERLINE CYLINDER

DOOR #:	1328A		QUANTITY:	1			
ARCHITECT'S DOOR #:	1328		DOOR OPENING:	3'-0"x 7'-10"			
LOCATION:	SF #W01	BAND/CHORUS	LEAVES:	Single	>		l _ l
MANUFACTURER:	Kawneer		SWING:	outswing	Supply	Q	Install
DOOR TYPE:	Insulpour	500T Thermal 2 1/4" doors	DOOR FINISH:	TBD	μĭ	Prep	nSt
FRAMING SYSTEM HEAD:	601UT sto	orefronts	ARCH. HW. SET:	16	יט	-	<del>-</del>
FRAMING SYSTEM JAMB:	601UT St	orefronts			¥	¥	メ
HARDWARE	QTY/LEAF	MANUFACTURER/DESCRIPTION	FINISH	NOTES/DIMENSIONS			
CONT HINGES	1	Ives 112HD-EPT	630				
OVERHEAD STOP	1	GLY 100S	630	Concealed heavy duty			
ACTIVE LEAF EXIT DEVICE	1	Von Duprin RX 35A-EO	626	1/2" INS Kit			
CLOSER	1	LCN 4040XP EDA	689				
CLOSER DROP PLATES	1	LCN 4040XP-18G	689				
DRIP CAP	1	Zero 142	626				
THRESHOLD	1	Kawneer Standard		By kawneer			
WEATHERSTRIPPING	1	Kawneer Standard		By kawneer			
DOOR SWEEPS	1	Zero 8198AA	626				
DOOR CONTACTS	1	Sce 679-05HM/WD		BY OTHERS			
POWER TRANSFERS	1	Von Duprin EPT 10 CON	689				

- ${\tt 1.}~{\tt COORDINATION}~{\tt OF}~{\tt ACCESS}~{\tt CONTROL},~{\tt ELECTRIC}~{\tt HARDWARE}~{\tt AND}~{\tt SECURITY}~{\tt SYSTEM}~{\tt BY}~{\tt OTHERS}.$
- $^{\star}$  FROM BOTTOM OF DOOR TO CENTERLINE OF TOP ATTACHMENT
- \*\* FROM BOTTOM OF DOOR TO CENTERLINE OF PUSH BAR
- \*\*\* FROM BOTTOM OF DOOR TO CENTERLINE CYLINDER
- \*\* FROM BOTTOM OF DOOR TO CENTERLINE OF PUSH BAR
- \*\*\* FROM BOTTOM OF DOOR TO CENTERLINE CYLINDER

DOOR #:	1550A		QUANTITY:	1			
ARCHITECT'S DOOR #:	1550		DOOR OPENING:	3'-0"x 7'-10"			
LOCATION:	SF # CAI	ETERIA	LEAVES:	Single	>		l _ l
MANUFACTURER:	Kawneer		SWING:	outswing	pply	Q	stal
DOOR TYPE:	Insulpour	500T Thermal 2 1/4" doors	DOOR FINISH:	TBD	Sup	Prep	nsi
FRAMING SYSTEM HEAD:	601UT sto	prefronts	ARCH. HW. SET:	2	יט	4	- I
FRAMING SYSTEM JAMB:	601UT St	orefronts			У	Y	¥
HARDWARE	QTY/LEAF	MANUFACTURER/DESCRIPTION	FINISH	NOTES/DIMENSIONS			
CONT HINGES	1	Ives 112HD-EPT	630				
OVERHEAD STOP	1	GLY 100S	630	Concealed heavy duty			
ACTIVE LEAF EXIT DEVICE	1	Von Duprin LD-RX-98-NL-OP	626	1/2" INS Kit			

RIM CYLINDER		Schlage, 7 Pin SFIC (as required)	626		
OFFSET PULLS	1	IVES 8190-0 10"	630		
CLOSER	1	LCN 4040XP SCUSH	689		
CLOSER DROP PLATES	1	LCN 4040XP-18G	689		
DRIP CAP	1	Zero 142	626		
THRESHOLD	1	Kawneer Standard		By kawneer	
WEATHERSTRIPPING	1	Kawneer Standard		By kawneer	
DOOR SWEEPS	1	Zero 8198AA	626		
DOOR CONTACTS	1	Sce 679-05HM/WD		BY OTHERS	
POWER SUPPLY	1	Von Duprin PS902 900-2RS		BY OTHERS	
POWER TRANSFERS	1	Von Duprin EPT 10 CON	689		

- 1. COORDINATION OF ACCESS CONTROL, ELECTRIC HARDWARE AND SECURITY SYSTEM BY OTHERS.
- \* FROM BOTTOM OF DOOR TO CENTERLINE OF TOP ATTACHMENT
- \*\* FROM BOTTOM OF DOOR TO CENTERLINE OF PUSH BAR
- \*\*\* FROM BOTTOM OF DOOR TO CENTERLINE CYLINDER

DOOR #:	4550D		OLIANITITY.	14			
			QUANTITY:				
ARCHITECT'S DOOR #:			DOOR OPENING:				
LOCATION:	SF # CAI	FETERIA	LEAVES:	Single	<u>&gt;</u>		l _
MANUFACTURER:	Kawneer		SWING:	outswing	dc	<u>Q</u>	ta
DOOR TYPE:	Insulpour	500T Thermal 2 1/4" doors	DOOR FINISH:	TBD	Supply	Prep	Install
FRAMING SYSTEM HEAD:	601UT sto	orefronts	ARCH. HW. SET:	2	-	Ψ.	<del>-</del>
FRAMING SYSTEM JAMB:	601UT St	orefronts			У	¥	¥
HARDWARE	QTY/LEAF	MANUFACTURER/DESCRIPTION	FINISH	NOTES/DIMENSIONS			
CONT HINGES	1	Ives 112HD-EPT	630				
OVERHEAD STOP	1	GLY 100S	630	Concealed heavy duty			
ACTIVE LEAF EXIT DEVICE	1	Von Duprin LD-RX-98-NL-OP	626	1/2" INS Kit			
RIM CYLINDER		Schlage, 7 Pin SFIC (as required)	626				
OFFSET PULLS	1	IVES 8190-0 10"	630				
CLOSER	1	LCN 4040XP SCUSH	689				
CLOSER DROP PLATES	1	LCN 4040XP-18G	689				
DRIP CAP	1	Zero 142	626				
THRESHOLD	1	Kawneer Standard		By kawneer			
WEATHERSTRIPPING	1	Kawneer Standard		By kawneer			
DOOR SWEEPS	1	Zero 8198AA	626				
DOOR CONTACTS	1	Sce 679-05HM/WD		BY OTHERS			
POWER SUPPLY	1	Von Duprin PS902 900-2RS		BY OTHERS			
POWER TRANSFERS	1	Von Duprin EPT 10 CON	689				

- ${\tt 1.}~{\tt COORDINATION}~{\tt OF}~{\tt ACCESS}~{\tt CONTROL},~{\tt ELECTRIC}~{\tt HARDWARE}~{\tt AND}~{\tt SECURITY}~{\tt SYSTEM}~{\tt BY}~{\tt OTHERS}.$
- \* FROM BOTTOM OF DOOR TO CENTERLINE OF TOP ATTACHMENT
- \*\* FROM BOTTOM OF DOOR TO CENTERLINE OF PUSH BAR
- \*\*\* FROM BOTTOM OF DOOR TO CENTERLINE CYLINDER

DOOR #:	1550C		QUANTITY:	1			
ARCHITECT'S DOOR #:	1550		<b>DOOR OPENING:</b>	3'-0"x 7'-10 1/8"			
LOCATION:	SF # CAI	FETERIA	LEAVES:	Single	>		_
MANUFACTURER:	Kawneer		SWING:	outswing	npply	rep	tal
DOOR TYPE:	Insulpour	350T Thermal 2 1/4" doors	DOOR FINISH:	TBD	Sul	Pre	nS
FRAMING SYSTEM HEAD:			ARCH. HW. SET:	2	-	Ξ.	$\bar{\tau}$
FRAMING SYSTEM JAMB:	601UT St	orefronts			¥	¥	¥
HARDWARE	QTY/LEAF	MANUFACTURER/DESCRIPTION	FINISH	NOTES/DIMENSIONS			
CONT HINGES	QTY/LEAF 1	MANUFACTURER/DESCRIPTION Ives 112HD-EPT	FINISH 630	NOTES/DIMENSIONS			
	QTY/LEAF 1 1			NOTES/DIMENSIONS  Concealed heavy duty			
CONT HINGES	1 1 1 1	Ives 112HD-EPT	630				
CONT HINGES OVERHEAD STOP	2TY/LEAF 1 1 1	Ives 112HD-EPT GLY 100S	630 630	Concealed heavy duty			
CONT HINGES OVERHEAD STOP ACTIVE LEAF EXIT DEVICE	1 1 1 1	Ives 112HD-EPT GLY 100S Von Duprin LD-RX-98-NL-OP	630 630 626	Concealed heavy duty			

CLOSER DROP PLATES	1	LCN 4040XP-18G	689			
DRIP CAP	1	Zero 142	626			
THRESHOLD	1	Kawneer Standard		By kawneer		
WEATHERSTRIPPING	1	Kawneer Standard		By kawneer		
DOOR SWEEPS	1	Zero 8198AA	626			
DOOR CONTACTS	1	Sce 679-05HM/WD		BY OTHERS		
POWER SUPPLY	1	Von Duprin PS902 900-2RS		BY OTHERS		
POWER TRANSFERS	1	Von Duprin EPT 10 CON	689			

- 1. COORDINATION OF ACCESS CONTROL, ELECTRIC HARDWARE AND SECURITY SYSTEM BY OTHERS.
- \* FROM BOTTOM OF DOOR TO CENTERLINE OF TOP ATTACHMENT
- \*\* FROM BOTTOM OF DOOR TO CENTERLINE OF PUSH BAR
- \*\*\* FROM BOTTOM OF DOOR TO CENTERLINE CYLINDER

				ī .	_		_
DOOR #:			QUANTITY:				
ARCHITECT'S DOOR #:	1600		DOOR OPENING:	3'-0"x 8'-0"			
LOCATION:	SF #W17	FABLAB/TECH	LEAVES:	Single	>		l _ l
MANUFACTURER:	Kawneer		SWING:	outswing	ಠ	р	ā
DOOR TYPE:	Insulpour	500T Thermal 2 1/4" doors	DOOR FINISH:	TBD	Supply	Prep	Install
FRAMING SYSTEM HEAD:	601UT sto	orefronts	ARCH. HW. SET:	2	S I	д.	-
FRAMING SYSTEM JAMB:	601UT St	orefronts			Х	¥	¥
HARDWARE	QTY/LEAF	MANUFACTURER/DESCRIPTION	FINISH	NOTES/DIMENSIONS			
CONT HINGES	1	Ives 112HD-EPT	630				
OVERHEAD STOP	1	GLY 100S	630	Concealed heavy duty			
ACTIVE LEAF EXIT DEVICE	1	Von Duprin LD-RX-98-NL-OP	626	1/2" INS Kit			
RIM CYLINDER		Schlage, 7 Pin SFIC (as required)	626				
OFFSET PULLS	1	IVES 8190-0 10"	630				
CLOSER	1	LCN 4040XP SCUSH	689				
CLOSER DROP PLATES	1	LCN 4040XP-18G	689				
DRIP CAP	1	Zero 142	626				
THRESHOLD	1	Kawneer Standard		By kawneer			
WEATHERSTRIPPING	1	Kawneer Standard		By kawneer			
DOOR SWEEPS	1	Zero 8198AA	626				
DOOR CONTACTS	1	Sce 679-05HM/WD		BY OTHERS			
POWER SUPPLY	1	Von Duprin PS902 900-2RS		BY OTHERS			
POWER TRANSFERS	1	Von Duprin EPT 10 CON	689				

- 1. COORDINATION OF ACCESS CONTROL, ELECTRIC HARDWARE AND SECURITY SYSTEM BY OTHERS.
- \* FROM BOTTOM OF DOOR TO CENTERLINE OF TOP ATTACHMENT
- \*\* FROM BOTTOM OF DOOR TO CENTERLINE OF PUSH BAR
- \*\*\* FROM BOTTOM OF DOOR TO CENTERLINE CYLINDER

DOOR #:	1680A		QUANTITY:	1			
ARCHITECT'S DOOR #:	1680		DOOR OPENING:	8'-0"x 8'-0 1/4"			
LOCATION:	SF #W19	MAKERSPACE/SHOP	LEAVES:	PAIR	>		l _ l
MANUFACTURER:	Kawneer		SWING:	outswing	ldc	Q	tal
DOOR TYPE:	Insulpour	500T Thermal 2 1/4" doors	DOOR FINISH:	TBD	Supply	Prep	nstall
FRAMING SYSTEM HEAD:	601UT sto	prefronts	ARCH. HW. SET:	7	,	+	- I
FRAMING SYSTEM JAMB:	601UT St	orefronts			¥	¥	メ
HARDWARE	QTY/LEAF	MANUFACTURER/DESCRIPTION	FINISH	NOTES/DIMENSIONS			
CONT HINGES	1	Ives 112HD-EPT	630				
OVERHEAD STOP	1	GLY 100S	630	Concealed heavy duty			
ACTIVE LEAF EXIT DEVICE	1	Von Duprin RX-QEL 35A-EO	US26D	1/2" INS Kit			
IN-ACTIVE LEAF EXIT DEVICE	1	Von Duprin RX-QEL 35A-NL-OP	US26D	1/2" INS Kit			
RIM CYLINDER	1	Schlage, 7 Pin SFIC (as required)	626				
MORTISE CYLINDER	1	Schlage, 7 Pin SFIC (as required)	626				
REMOVABLE MULLION	1	VON DUPRIN KR4954	626				
OFFSET PULLS	1	ROCKWOOD RM3310x48"	630				

CLOSER	1	LCN 4040XP EDA	689			
CLOSER DROP PLATES	1	LCN 4040XP-18G	689			
DRIP CAP	1	Zero 142	626			
THRESHOLD	1	Kawneer Standard		By kawneer		
WEATHERSTRIPPING	1	Kawneer Standard		By kawneer		
DOOR SWEEPS	1	Zero 8198AA	626			
DOOR CONTACTS	1	Sce 679-05HM/WD		BY OTHERS		

- 1. COORDINATION OF ACCESS CONTROL, ELECTRIC HARDWARE AND SECURITY SYSTEM BY OTHERS.
- \* FROM BOTTOM OF DOOR TO CENTERLINE OF TOP ATTACHMENT
- \*\* FROM BOTTOM OF DOOR TO CENTERLINE OF PUSH BAR
- \*\*\* FROM BOTTOM OF DOOR TO CENTERLINE CYLINDER

DOOR #:	2070A		QUANTITY:	1			
ARCHITECT'S DOOR #:	2070		DOOR OPENING:	3'-0"x 7'-10"			
LOCATION:	SF #E36	STAIR 7	LEAVES:	Single	>		l _ l
MANUFACTURER:	Kawneer		SWING:	outswing	ldc	d	<u>a</u>
DOOR TYPE:	Insulpour	500T Thermal 2 1/4" doors	DOOR FINISH:	TBD	Supply	Prep	Install
FRAMING SYSTEM HEAD:	601UT sto	orefronts	ARCH. HW. SET:	16	9	4	<del>-</del>
FRAMING SYSTEM JAMB:	601UT St	orefronts			¥	Y	¥
HARDWARE	QTY/LEAF	MANUFACTURER/DESCRIPTION	FINISH	NOTES/DIMENSIONS			
CONT HINGES	1	Ives 112HD-EPT	630				
OVERHEAD STOP	1	GLY 100S	630	Concealed heavy duty			
ACTIVE LEAF EXIT DEVICE	1	Von Duprin RX 35A-EO	626	1/2" INS Kit			
CLOSER	1	LCN 4040XP EDA	689				
CLOSER DROP PLATES	1	LCN 4040XP-18G	689				
DRIP CAP	1	Zero 142	626				
THRESHOLD	1	Kawneer Standard		By kawneer			
WEATHERSTRIPPING	1	Kawneer Standard		By kawneer			
DOOR SWEEPS	1	Zero 8198AA	626				
DOOR CONTACTS	1	Sce 679-05HM/WD		BY OTHERS			
POWER TRANSFERS	1	Von Duprin EPT 10 CON	689				

- 1. COORDINATION OF ACCESS CONTROL, ELECTRIC HARDWARE AND SECURITY SYSTEM BY OTHERS.
- \* FROM BOTTOM OF DOOR TO CENTERLINE OF TOP ATTACHMENT
- \*\* FROM BOTTOM OF DOOR TO CENTERLINE OF PUSH BAR
- \*\*\* FROM BOTTOM OF DOOR TO CENTERLINE CYLINDER

DOOR #:	2075A		QUANTITY:	1			
ARCHITECT'S DOOR #:	2075		DOOR OPENING:	3'-0"x 7'-8"			
LOCATION:	SF #E37	VESTIBULE	LEAVES:	Single	>		I_
MANUFACTURER:	Kawneer		SWING:	outswing	Supply	<u>a</u>	Install
DOOR TYPE:	Insulpour	500T Thermal 2 1/4" doors	DOOR FINISH:	TBD	'n	Prep	nsi
FRAMING SYSTEM HEAD:	601UT sto	prefronts	ARCH. HW. SET:	1	י	+	=
FRAMING SYSTEM JAMB:	601UT St	orefronts			¥	X	노
HARDWARE	QTY/LEAF	MANUFACTURER/DESCRIPTION	FINISH	NOTES/DIMENSIONS			
CONT HINGES	1	Ives 112HD-EPT	630				
OVERHEAD STOP	1	GLY 100S	630	Concealed heavy duty			
ACTIVE LEAF EXIT DEVICE	1	Von Duprin RX-QEL 35A-NL-OP	626	1/2" INS Kit			
RIM CYLINDER		Schlage, 7 Pin SFIC (as required)	626				
OFFSET PULLS	1	Rockwood RM3310 x 48	630				
AUTO OPERATOR	1	LCN 4640 (push side)	689				
WALL ACTUATOR	1	LCN 8310-818T	630				
WALL ACTUATOR	1	LCN 8310-855 (Vestibule)	630				
DRIP CAP	1	Zero 142	626				
THRESHOLD	1	Kawneer Standard		By kawneer			

WEATHERSTRIPPING	1	Kawneer Standard		By kawneer		
DOOR SWEEPS	1	Zero 8198AA	626			
DOOR CONTACTS	1	Sce 679-05HM/WD		BY OTHERS		
POWER SUPPLY	1	Von Duprin PS902 900-2RS		BY OTHERS		
POWER TRANSFERS	1	Von Duprin EPT 10 CON	689			

- 1. COORDINATION OF ACCESS CONTROL, ELECTRIC HARDWARE AND SECURITY SYSTEM BY OTHERS.
- \* FROM BOTTOM OF DOOR TO CENTERLINE OF TOP ATTACHMENT
- \*\* FROM BOTTOM OF DOOR TO CENTERLINE OF PUSH BAR
- \*\*\* FROM BOTTOM OF DOOR TO CENTERLINE CYLINDER

DOOR #:	2085		QUANTITY:	1			
ARCHITECT'S DOOR #:	2085		DOOR OPENING:	3'-0"x 7'-10"			
LOCATION:	SF #E41	VESTIBULE	LEAVES:	Single	>		l _ '
MANUFACTURER:	Kawneer		SWING:	outswing	Supply	d	nstall
DOOR TYPE:	Insulpour	500T Thermal 2 1/4" doors	DOOR FINISH:	TBD	ğπ	Prep	nsi
FRAMING SYSTEM HEAD:	601UT sto	orefronts	ARCH. HW. SET:	12	0)	-	<del>-</del>
FRAMING SYSTEM JAMB:	601UT St	orefronts			¥	¥	メ
HARDWARE	QTY/LEAF	MANUFACTURER/DESCRIPTION	FINISH	NOTES/DIMENSIONS			
CONT HINGES	1	Ives 112HD-EPT	630				
OVERHEAD STOP	1	GLY 100S	630	Concealed heavy duty			
ACTIVE LEAF EXIT DEVICE	1	Von Duprin CD-98-L-NL-06	626	1/2" INS Kit			
RIM CYLINDER		Schlage, 7 Pin SFIC (as required)	626				
CLOSER	1	LCN 4040XP SCUSH	689				
CLOSER DROP PLATES	1	LCN 4040XP-18G	689				
WEATHERSTRIPPING	1	Kawneer Standard		By kawneer			

- ${\tt 1.}~{\tt COORDINATION}~{\tt OF}~{\tt ACCESS}~{\tt CONTROL},~{\tt ELECTRIC}~{\tt HARDWARE}~{\tt AND}~{\tt SECURITY}~{\tt SYSTEM}~{\tt BY}~{\tt OTHERS}.$
- \* FROM BOTTOM OF DOOR TO CENTERLINE OF TOP ATTACHMENT
- \*\* FROM BOTTOM OF DOOR TO CENTERLINE OF PUSH BAR
- \*\*\* FROM BOTTOM OF DOOR TO CENTERLINE CYLINDER

DOOR #:	2085A		QUANTITY:	1			
ARCHITECT'S DOOR #:	2085		DOOR OPENING:	3'-0"x 7'-10"			
LOCATION:	SF #E42 \	VESTIBULE	LEAVES:	Single	>		l _ l
MANUFACTURER:	Kawneer		SWING:	outswing	Supply	۵	Install
DOOR TYPE:	Insulpour	500T Thermal 2 1/4" doors	DOOR FINISH:	TBD	'nξ	Prep	us
FRAMING SYSTEM HEAD:	601UT sto	prefronts	ARCH. HW. SET:	3	יט	<u> </u>	<del>-</del>
FRAMING SYSTEM JAMB:	601UT St	orefronts			¥	¥	¥
HARDWARE	QTY/LEAF	MANUFACTURER/DESCRIPTION	FINISH	NOTES/DIMENSIONS			
CONT HINGES	1	Ives 112HD-EPT	630				
OVERHEAD STOP	1	GLY 100S	630	Concealed heavy duty			
ACTIVE LEAF EXIT DEVICE	1	Von Duprin LD-RX-98-NL-OP-110MD-ALK-WH	626	1/2" INS Kit			
RIM CYLINDER		Schlage, 7 Pin SFIC (as required)	626				
MORTISE CYLINDER	1	Schlage, 7 Pin SFIC (as required)	626				
OFFSET PULLS	1	IVES 8190-0 10"	630				
CLOSER	1	LCN 4040XP SCUSH	689				
CLOSER DROP PLATES	1	LCN 4040XP-18G	689				
DRIP CAP	1	Zero 142	626				
THRESHOLD	1	Kawneer Standard		By kawneer			
WEATHERSTRIPPING	1	Kawneer Standard		By kawneer			
DOOR SWEEPS	1	Zero 8198AA	626				

DOOR CONTACTS	1	Sce 679-05HM/WD		BY OTHERS		
CARD READER		BY OTHERS		BY OTHERS		
POWER SUPPLY	1	Von Duprin PS902 900-2RS		BY OTHERS		
POWER TRANSFERS	1	Von Duprin EPT 10 CON	689			

- 1. COORDINATION OF ACCESS CONTROL, ELECTRIC HARDWARE AND SECURITY SYSTEM BY OTHERS.
- \* FROM BOTTOM OF DOOR TO CENTERLINE OF TOP ATTACHMENT
- \*\* FROM BOTTOM OF DOOR TO CENTERLINE OF PUSH BAR
- \*\*\* FROM BOTTOM OF DOOR TO CENTERLINE CYLINDER

DOOR #:	2535A		QUANTITY:	1			
ARCHITECT'S DOOR #:	2535		DOOR OPENING:	3'-0"x 7'-10 "			
LOCATION:	SF #W33	PROJECT TERRACE	LEAVES:	SINGLE	>		l _
MANUFACTURER:	Kawneer		SWING:	outswing	Supply	۵	Install
DOOR TYPE:	Insulpour	500T Thermal 2 1/4" doors	DOOR FINISH:	TBD	Įή	Prep	nsi
FRAMING SYSTEM HEAD:			ARCH. HW. SET:	6	יט	÷	-
FRAMING SYSTEM JAMB:	601UT St	orefronts			¥	メ	メ
HARDWARE	QTY/LEAF	MANUFACTURER/DESCRIPTION	FINISH	NOTES/DIMENSIONS			
CONT HINGES	1	Ives 112HD-EPT	630				
OVERHEAD STOP	1	GLY 100S	630	Concealed heavy duty			
ACTIVE LEAF EXIT DEVICE	1	Von Duprin CD 35A-NL-OP	US26D	1/2" INS Kit			
RIM CYLINDER	1	Schlage, 7 Pin SFIC (as required)	626				
MORTISE CYLINDER	1	Schlage, 7 Pin SFIC (as required)	626				
REMOVABLE MULLION	1	VON DUPRIN KR4954	626				
OFFSET PULLS	1	ROCKWOOD RM3310x48"	630				
CLOSER	1	LCN 4040XP EDA	689				
CLOSER DROP PLATES	1	LCN 4040XP-18G	689				
DRIP CAP	1	Zero 142	626				
THRESHOLD	1	Kawneer Standard		By kawneer			
WEATHERSTRIPPING	1	Kawneer Standard		By kawneer			
DOOR SWEEPS	1	Zero 8198AA	626				
DOOR CONTACTS	1	Sce 679-05HM/WD		BY OTHERS			

- 1. COORDINATION OF ACCESS CONTROL, ELECTRIC HARDWARE AND SECURITY SYSTEM BY OTHERS.
- \* FROM BOTTOM OF DOOR TO CENTERLINE OF TOP ATTACHMENT
- \*\* FROM BOTTOM OF DOOR TO CENTERLINE OF PUSH BAR
- \*\*\* FROM BOTTOM OF DOOR TO CENTERLINE CYLINDER

							_
DOOR #:	2535B		QUANTITY:	1			
ARCHITECT'S DOOR #:	2535		DOOR OPENING:	3'-0"x 7'-10 "			
LOCATION:	SF #W35	PROJECT TERRACE	LEAVES:	SINGLE	Λ		_
MANUFACTURER:	Kawneer		SWING:	outswing	ldc	Q	tal
DOOR TYPE:	Insulpour	500T Thermal 2 1/4" doors	DOOR FINISH:	TBD	Supply	Prep	Install
FRAMING SYSTEM HEAD:	601UT sto	orefronts	ARCH. HW. SET:	6	5	4	- I
FRAMING SYSTEM JAMB:	601UT St	orefronts			Y	¥	¥
HARDWARE	QTY/LEAF	MANUFACTURER/DESCRIPTION	FINISH	NOTES/DIMENSIONS			
CONT HINGES	1	Ives 112HD-EPT	630				
OVERHEAD STOP	1	GLY 100S	630	Concealed heavy duty			
ACTIVE LEAF EXIT DEVICE	1	Von Duprin CD 35A-NL-OP	US26D	1/2" INS Kit			
RIM CYLINDER	1	Schlage, 7 Pin SFIC (as required)	626				
MORTISE CYLINDER	1	Schlage, 7 Pin SFIC (as required)	626				
REMOVABLE MULLION	1	VON DUPRIN KR4954	626				
OFFSET PULLS	1	ROCKWOOD RM3310x48"	630				
CLOSER	1	LCN 4040XP EDA	689				
CLOSER DROP PLATES	1	LCN 4040XP-18G	689				
DRIP CAP	1	Zero 142	626				
THRESHOLD	1	Kawneer Standard		By kawneer			
WEATHERSTRIPPING	1	Kawneer Standard		By kawneer			
DOOR SWEEPS	1	Zero 8198AA	626				
DOOR CONTACTS	1	Sce 679-05HM/WD		BY OTHERS			

- 1. COORDINATION OF ACCESS CONTROL, ELECTRIC HARDWARE AND SECURITY SYSTEM BY OTHERS.
- \* FROM BOTTOM OF DOOR TO CENTERLINE OF TOP ATTACHMENT
- \*\* FROM BOTTOM OF DOOR TO CENTERLINE OF PUSH BAR
- \*\*\* FROM BOTTOM OF DOOR TO CENTERLINE CYLINDER

DOOR #:	2710A		QUANTITY:	1			
ARCHITECT'S DOOR #:	2710		DOOR OPENING:	3'-0"x 8'-0 1/4"			
LOCATION:	SF #E05	PRE KINDERGARDEN	LEAVES:	SINGLE	Α		l _ l
MANUFACTURER:	Kawneer		SWING:	outswing	Supply	Q	Install
DOOR TYPE:	Insulpour	500T Thermal 2 1/4" doors	DOOR FINISH:	TBD	'n	rep	nsi
FRAMING SYSTEM HEAD:	601UT sto	orefronts	ARCH. HW. SET:	4	יט	-	<del>-</del>
FRAMING SYSTEM JAMB:	601UT St	orefronts			¥	¥	メ
HARDWARE	QTY/LEAF	MANUFACTURER/DESCRIPTION	FINISH	NOTES/DIMENSIONS			
CONT HINGES	1	Ives 112HD-EPT	630				
OVERHEAD STOP	1	GLY 100S	630	Concealed heavy duty			
STOREROOM LOCK	1	SCHLAGE L9080	US26D	1/2" INS Kit			
CLOSER	1	LCN 4040XP REG OR PA (AS REQUIRED)	689				
CLOSER DROP PLATES	1	LCN 4040XP-18G	689				
KICK PLATE	1	IVES 8400 10" X 2" LDW B-CS					
DRIP CAP	1	Zero 142	626				
GASKETING	set	ZERO 429					
THRESHOLD	1	ZERO 8655G (verify jamb depth)		By kawneer			
DOOR SWEEPS	1	Zero 8198AA	626				
DOOR CONTACTS	1	Sce 679-05HM/WD		BY OTHERS			

#### NOTES

- 1. COORDINATION OF ACCESS CONTROL, ELECTRIC HARDWARE AND SECURITY SYSTEM BY OTHERS.
- \* FROM BOTTOM OF DOOR TO CENTERLINE OF TOP ATTACHMENT
- \*\* FROM BOTTOM OF DOOR TO CENTERLINE OF PUSH BAR
- \*\*\* FROM BOTTOM OF DOOR TO CENTERLINE CYLINDER

DOOR #:	2718A		QUANTITY:	1			
ARCHITECT'S DOOR #:	2718		DOOR OPENING:	3'-0"x 8'-0 1/4"			
LOCATION:	SF #E06	PRE KINDERGARDEN	LEAVES:	SINGLE	>	l	l _ l
MANUFACTURER:	Kawneer		SWING:	outswing	dc	٩	ta
DOOR TYPE:	Insulpour	500T Thermal 2 1/4" doors	DOOR FINISH:	TBD	Supply	Prep	Install
FRAMING SYSTEM HEAD:	601UT sto	prefronts	ARCH. HW. SET:	4	יט	<u>٠</u>	<del>-</del>
FRAMING SYSTEM JAMB:	601UT St	orefronts			¥	Y	メ
HARDWARE	QTY/LEAF	MANUFACTURER/DESCRIPTION	FINISH	NOTES/DIMENSIONS			
CONT HINGES	1	Ives 112HD-EPT	630			L	
OVERHEAD STOP	1	GLY 100S	630	Concealed heavy duty			
STOREROOM LOCK	1	SCHLAGE L9080	US26D	1/2" INS Kit			
CLOSER	1	LCN 4040XP REG OR PA (AS REQUIRED)	689				
CLOSER DROP PLATES	1	LCN 4040XP-18G	689				
KICK PLATE	1	IVES 8400 10" X 2" LDW B-CS					
DRIP CAP	1	Zero 142	626				
GASKETING	set	ZERO 429					
THRESHOLD	1	ZERO 8655G (verify jamb depth)		By kawneer			
DOOR SWEEPS	1	Zero 8198AA	626				
DOOR CONTACTS	1	Sce 679-05HM/WD		BY OTHERS			

- 1. COORDINATION OF ACCESS CONTROL, ELECTRIC HARDWARE AND SECURITY SYSTEM BY OTHERS.
- \* FROM BOTTOM OF DOOR TO CENTERLINE OF TOP ATTACHMENT
- \*\* FROM BOTTOM OF DOOR TO CENTERLINE OF PUSH BAR
- \*\*\* FROM BOTTOM OF DOOR TO CENTERLINE CYLINDER

DOOR #:	2720A		QUANTITY:	1			
ARCHITECT'S DOOR #:	2720		DOOR OPENING:	3'-0"x 8'-0 1/4"			
LOCATION:	SF #E09	PRE KINDERGARDEN	LEAVES:	SINGLE	>		_
MANUFACTURER:	Kawneer		SWING:	outswing	ldc	۵	[a]
DOOR TYPE:	Insulpour	500T Thermal 2 1/4" doors	DOOR FINISH:	TBD	Supply	Prep	Install
FRAMING SYSTEM HEAD:	601UT sto	prefronts	ARCH. HW. SET:	4	-	<u> </u>	=
FRAMING SYSTEM JAMB:	601UT St	orefronts			X	X	メ
HARDWARE	QTY/LEAF	MANUFACTURER/DESCRIPTION	FINISH	NOTES/DIMENSIONS			
CONT HINGES	1	Ives 112HD-EPT	630				
OVERHEAD STOP	1	GLY 100S	630	Concealed heavy duty			
STOREROOM LOCK	1	SCHLAGE L9080	US26D	1/2" INS Kit			
CLOSER	1	LCN 4040XP REG OR PA (AS REQUIRED)	689				
CLOSER DROP PLATES	1	LCN 4040XP-18G	689				
KICK PLATE	1	IVES 8400 10" X 2" LDW B-CS					
DRIP CAP	1	Zero 142	626				
GASKETING	set	ZERO 429					
THRESHOLD	1	ZERO 8655G (verify jamb depth)		By kawneer			
DOOR SWEEPS	1	Zero 8198AA	626				
DOOR CONTACTS	1	Sce 679-05HM/WD		BY OTHERS			

DOOR #:	2910A		QUANTITY:	1			
ARCHITECT'S DOOR #:	2910		DOOR OPENING:	3'-0"x 8'-0 1/4"			
LOCATION:	SF #E43	KINDERGARDEN	LEAVES:	SINGLE	>		l _ l
MANUFACTURER:	Kawneer		SWING:	outswing	Supply	Q	Install
DOOR TYPE:	Insulpour	500T Thermal 2 1/4" doors	DOOR FINISH:	TBD	'nξ	Prep	nSi
FRAMING SYSTEM HEAD:	601UT sto	prefronts	ARCH. HW. SET:	4	5	4	<del>-</del>
FRAMING SYSTEM JAMB:	601UT St	orefronts			¥	Y	¥
HARDWARE	QTY/LEAF	MANUFACTURER/DESCRIPTION	FINISH	NOTES/DIMENSIONS			
CONT HINGES	1	Ives 112HD-EPT	630				
OVERHEAD STOP	1	GLY 100S	630	Concealed heavy duty			
STOREROOM LOCK	1	SCHLAGE L9080	US26D	1/2" INS Kit			
CLOSER	1	LCN 4040XP REG OR PA (AS REQUIRED)	689				
CLOSER DROP PLATES	1	LCN 4040XP-18G	689				
KICK PLATE	1	IVES 8400 10" X 2" LDW B-CS					
DRIP CAP	1	Zero 142	626				
GASKETING	set	ZERO 429					
THRESHOLD	1	ZERO 8655G (verify jamb depth)		By kawneer			
DOOR SWEEPS	1	Zero 8198AA	626				
DOOR CONTACTS	1	Sce 679-05HM/WD		BY OTHERS			

<sup>\*\*\*</sup> FROM BOTTOM OF DOOR TO CENTERLINE CYLINDER

					_
DOOR #:	2918A	QUANTITY:	1		

<sup>1.</sup> COORDINATION OF ACCESS CONTROL, ELECTRIC HARDWARE AND SECURITY SYSTEM BY OTHERS.

<sup>\*</sup> FROM BOTTOM OF DOOR TO CENTERLINE OF TOP ATTACHMENT

<sup>\*\*</sup> FROM BOTTOM OF DOOR TO CENTERLINE OF PUSH BAR

<sup>\*\*\*</sup> FROM BOTTOM OF DOOR TO CENTERLINE CYLINDER

<sup>1.</sup> COORDINATION OF ACCESS CONTROL, ELECTRIC HARDWARE AND SECURITY SYSTEM BY OTHERS.

<sup>\*</sup> FROM BOTTOM OF DOOR TO CENTERLINE OF TOP ATTACHMENT

<sup>\*\*</sup> FROM BOTTOM OF DOOR TO CENTERLINE OF PUSH BAR

ARCHITECT'S DOOR #:	2918		DOOR OPENING:	3'-0"x 7'-11"			
LOCATION:	SF #E11	KINDERGARDEN	LEAVES:	SINGLE	>		l _ l
MANUFACTURER:	Kawneer		SWING:	outswing	ldc	٩	tal
DOOR TYPE:	Insulpour	500T Thermal 2 1/4" doors	DOOR FINISH:	TBD	Supply	Prep	nstall
FRAMING SYSTEM HEAD:	601UT sto	prefronts	ARCH. HW. SET:	4	יט	Ψ.	<del>-</del>
FRAMING SYSTEM JAMB:	601UT St	orefronts			¥	¥	メ
HARDWARE	QTY/LEAF	MANUFACTURER/DESCRIPTION	FINISH	NOTES/DIMENSIONS			
CONT HINGES	1	Ives 112HD-EPT	630				
OVERHEAD STOP	1	GLY 100S	630	Concealed heavy duty			
STOREROOM LOCK	1	SCHLAGE L9080	US26D	1/2" INS Kit			
CLOSER	1	LCN 4040XP REG OR PA (AS REQUIRED)	689				
CLOSER DROP PLATES	1	LCN 4040XP-18G	689				
KICK PLATE	1	IVES 8400 10" X 2" LDW B-CS					
DRIP CAP	1	Zero 142	626				
GASKETING	set	ZERO 429					
THRESHOLD	1	ZERO 8655G (verify jamb depth)		By kawneer			
DOOR SWEEPS	1	Zero 8198AA	626				
DOOR CONTACTS	1	Sce 679-05HM/WD		BY OTHERS			

- 1. COORDINATION OF ACCESS CONTROL, ELECTRIC HARDWARE AND SECURITY SYSTEM BY OTHERS.
- \* FROM BOTTOM OF DOOR TO CENTERLINE OF TOP ATTACHMENT
- \*\* FROM BOTTOM OF DOOR TO CENTERLINE OF PUSH BAR
- \*\*\* FROM BOTTOM OF DOOR TO CENTERLINE CYLINDER

DOOR #:	2920A		QUANTITY:	1			
ARCHITECT'S DOOR #:	2920		DOOR OPENING:	3'-0"x 8'-0"			
LOCATION:	SF #E12	KINDERGARDEN	LEAVES:	SINGLE	>		l _ l
MANUFACTURER:	Kawneer		SWING:	outswing	ldc	Q	<u>ra</u>
DOOR TYPE:	Insulpour	500T Thermal 2 1/4" doors	DOOR FINISH:	TBD	Supply	Prep	Install
FRAMING SYSTEM HEAD:	601UT sto	orefronts	ARCH. HW. SET:	4	יט	<u> </u>	<del>-</del>
FRAMING SYSTEM JAMB:	601UT St	orefronts			¥	K	¥
HARDWARE	QTY/LEAF	MANUFACTURER/DESCRIPTION	FINISH	NOTES/DIMENSIONS			
CONT HINGES	1	Ives 112HD-EPT	630				
OVERHEAD STOP	1	GLY 100S	630	Concealed heavy duty			
STOREROOM LOCK	1	SCHLAGE L9080	US26D	1/2" INS Kit			
CLOSER	1	LCN 4040XP REG OR PA (AS REQUIRED)	689				
CLOSER DROP PLATES	1	LCN 4040XP-18G	689				
KICK PLATE	1	IVES 8400 10" X 2" LDW B-CS					
DRIP CAP	1	Zero 142	626				
GASKETING	set	ZERO 429					
THRESHOLD	1	ZERO 8655G (verify jamb depth)		By kawneer			
DOOR SWEEPS	1	Zero 8198AA	626				
DOOR CONTACTS	1	Sce 679-05HM/WD		BY OTHERS			

- 1. COORDINATION OF ACCESS CONTROL, ELECTRIC HARDWARE AND SECURITY SYSTEM BY OTHERS.
- \* FROM BOTTOM OF DOOR TO CENTERLINE OF TOP ATTACHMENT
- \*\* FROM BOTTOM OF DOOR TO CENTERLINE OF PUSH BAR
- \*\*\* FROM BOTTOM OF DOOR TO CENTERLINE CYLINDER

Ī	DOOR #:	2928A	QUANTITY:	1		
	ARCHITECT'S DOOR #:	2928	DOOR OPENING:	3'-0"x 8'-0 1/4"		

LOCATION:	SF #E14	KINDERGARDEN	LEAVES:	SINGLE	>		I _ I
MANUFACTURER:	Kawneer		SWING:	outswing	Supply	۵	Install
DOOR TYPE:	Insulpour	500T Thermal 2 1/4" doors	DOOR FINISH:	TBD	ıμί	Prep	JS
FRAMING SYSTEM HEAD:	601UT sto	prefronts	ARCH. HW. SET:	4	5	<u>.</u>	<del>-</del>
FRAMING SYSTEM JAMB:	601UT St	orefronts			¥	Y	メ
HARDWARE	QTY/LEAF	MANUFACTURER/DESCRIPTION	FINISH	NOTES/DIMENSIONS			
CONT HINGES	1	Ives 112HD-EPT	630				
OVERHEAD STOP	1	GLY 100S	630	Concealed heavy duty			
STOREROOM LOCK	1	SCHLAGE L9080	US26D	1/2" INS Kit			
CLOSER	1	LCN 4040XP REG OR PA (AS REQUIRED)	689				
CLOSER DROP PLATES	1	LCN 4040XP-18G	689				
KICK PLATE	1	IVES 8400 10" X 2" LDW B-CS					
DRIP CAP	1	Zero 142	626				
GASKETING	set	ZERO 429					
THRESHOLD	1	ZERO 8655G (verify jamb depth)		By kawneer			
DOOR SWEEPS	1	Zero 8198AA	626				
DOOR CONTACTS	1	Sce 679-05HM/WD		BY OTHERS			

<sup>1.</sup> COORDINATION OF ACCESS CONTROL, ELECTRIC HARDWARE AND SECURITY SYSTEM BY OTHERS.

<sup>\*</sup> FROM BOTTOM OF DOOR TO CENTERLINE OF TOP ATTACHMENT

<sup>\*\*</sup> FROM BOTTOM OF DOOR TO CENTERLINE OF PUSH BAR

<sup>\*\*\*</sup> FROM BOTTOM OF DOOR TO CENTERLINE CYLINDER



Gilbane Building Company 10 Channel Center Street Suite 100

Boston, Massachusetts 02210 Phone: (617) 478-2981 Project: J08864.000 - Michael Driscoll School - Brookline 64 Westbourne Terrace Brookline, Massachusetts 02446

Jeff Ray (Salem Glass Company)

08 41 13 - ALUMINUM-FRAMED

**ENTRANCES AND STOREFRONTS** 

Open

11/07/2021

# Wide Style Door Leaf

FROM:

STATUS:

**DUE DATE:** 

COST CODE:

SPEC SECTION:

REFERENCE:

SCHEDULE IMPACT: TBD

TO: James Machek (Jonathan Levi Architects LLC)

Mark Warner (Jonathan Levi Architects LLC) Juho Lee (Jonathan Levi Architects LLC) Carol Harris (Jonathan Levi Architects LLC)

DATE INITIATED: 11/02/2021 LOCATION: FLOOR 1

PROJECT STAGE: Pre-Construction

SUB JOB:

COST IMPACT: Yes (Unknown)

DRAWING NUMBER: LINKED DRAWINGS:

RECEIVED FROM: Jeff Ray (Salem Glass Company)

COPIES TO:

Robert Braga (Gilbane Building Company), Colleen Shouldice (Gilbane Building Company), John Cunha (Central Ceilings Inc), Kevin Estano (Central Ceilings Inc), William Heiberger (Gilbane Building Company), Benjamin Peek (Gilbane Building Company), Jeff Ray (Salem Glass Company), Brady Whitehill (Gilbane Building Company)

#### Question from Jeff Ray (Salem Glass Company) at 09:05 AM on 11/02/2021

In reference to the Architects desire to change all the doors from medium style to wide style door leafs, I had Kawneer review the door hardware to verify what did or did not fit on medium style doors and re quote all the doors to Wide style doors to confirm what the cost difference would be from what Salem carried. Highlighted colors related to highlighted Quote

- · There are still doors that have specified hardware that do not fit on Medium style doors
- There is specific hardware (Auto operators) that Kawneer recommends changing due to excessive usage
- There is specific hardware that cannot be applied as requested (Top jamb mounted closer drop plates) and kawneer has recommended alternatives Some of these doors either need different hardware or need to be changed to wide style thermal doors in order to install the specified hardware Not all doors need to be wide style doors (see attached marked up Quote) per kawneer's review of the hardware spec and door schedule, 13 door leafs would need to be wide style to accommodate the specified hardware and the remaining doors can stay as Medium style doors. There is a added per leaf cost impact to changing the width of the door styles from Medium 3 1/2" to wide style 5" door rails.

  Will the city/Architect be ok with having two different width door leaf's ???

The other option would be to change ALL 31 doors (Larger added cost) to a 5" wide style door rail width in order to install certain hardware and be consistent through out the project.

Please advise

#### Attachments:

Hardware Schedule1.pdf Kawneer wide style doors with hardware.pdf

Awaiting an Official Response

#### **All Replies:**

If the information provided in the resunless authorized to do so by the Co(5) working days from receipt of the Agreement. Should no change be resulted.	, onstruction Manager in writing. Th nis Request for Information that	e trade contractor shall provid this RFI constitutes a chan	de the Construction Manager writte ge, all in accordance with Article	n notice within five
RY	DATE		COPIES TO	

DOOR #:	10014		QUANTITY:	14	_		
		TO THE STATE OF TH					
ARCHITECT'S DOOR #:		N. (1)	DOOR OPENING:		1		
		ntry Vestibule	LEAVES:		>		l _
MANUFACTURER:			SWING:	Outswing	ᅙ	d	ā
The second secon		350T Thermal 2 1/4" doors	DOOR FINISH:	TBD	Supply	Prep	Install
FRAMING SYSTEM HEAD:	601UT sto	refronts	ARCH. HW. SET:	8	် လ	<u>-</u>	≒
FRAMING SYSTEM JAMB:	601UT Sto	refronts			Y	¥	¥
HARDWARE	QTY/LEAF	MANUFACTURER/DESCRIPTION	FINISH	NOTES/DIMENSIONS			
CONT HINGES	1	Ives 112HD-EPT	630				
OVERHEAD STOP	1	GLY 100S	630	Concealed heavy duty			
ACTIVE LEAF EXIT DEVICE	1	Von Duprin RX-QEL 35A-EO	US26D	1/2" INS Kit			
IN-ACTIVE LEAF EXIT DEVICE	1	Von Duprin RX-QEL 35A-NL-OP	US26D	1/2" INS Kit			
RIM CYLINDER	1	Schlage, 7 Pin SFIC (as required)	626				
MORTISE CYLINDER	1	Schlage, 7 Pin SFIC (as required)	626				
REMOVABLE MULLION	1	VON DUPRIN KR4954	626	WIF IN A STATE OF THE STATE OF			
OFFSET PULLS	1	ROCKWOOD RM3310x48"	630	4.00			
CLOSER	1	LCN 4040XP EDA	689				
CLOSER DROP PLATES	1	LCN 4040XP-18G	689				
DRIP CAP	1	Zero 142	626				-
THRESHOLD	1	Kawneer Standard		By kawneer			
WEATHERSTRIPPING	1	Kawneer Standard		By kawneer		T	
DOOR SWEEPS	1	Zero 8198AA	626				
DOOR CONTACTS	1	Sce 679-05HM/WD		BY OTHERS			一
CARD READER		BY OTHERS	***************************************	BY OTHERS			
POWER SUPPLY	1	Von Duprin PS902 900-2RS	MANAGE	BY OTHERS		1	
POWER TRANSFERS	1	Von Duprin EPT 10 CON	689				

- 1. COORDINATION OF ACCESS CONTROL, ELECTRIC HARDWARE AND SECURITY SYSTEM BY OTHERS.
- \* FROM BOTTOM OF DOOR TO CENTERLINE OF TOP ATTACHMENT
- \*\* FROM BOTTOM OF DOOR TO CENTERLINE OF PUSH BAR
- \*\*\* FROM BOTTOM OF DOOR TO CENTERLINE CYLINDER

1001B		QUANTITY:	1			
1001	TOTAL AND COLOR OF THE VICE CO	DOOR OPENING:	3'-0"- 7'-10"			
SF #S06 E	ntry Vestibule	LEAVES:	Single			
Kawneer		SWING:	Outswing	盲		Install
Insulpour 3	50T Thermal 2 1/4" doors	DOOR FINISH:	TBD	ဌ	ē	St
601UT stor	refronts	ARCH. HW. SET:	1	Ś	Δ.	<del>-</del>
601UT Sto	refronts			×	ż,	-
QTY/LEAF	MANUFACTURER/DESCRIPTION	FINISH	NOTES/DIMENSIONS			
1	Ives 112HD-EPT	630				
1	GLY 100S	630	Concealed heavy duty			
1	Von Duprin RX-QEL 35A-NL-OP	626	1/2" INS Kit			
	Schlage, 7 Pin SFIC (as required)	626				
1	Rockwood RM3310 x 48	630	***************************************			
1	LCN 4640 (push side)	689	7.0			
1	LCN 8310-818T	630				
1	LCN 8310-855 (Vestibule)	630				
1	Zero 142	626				
1	Kawneer Standard		By kawneer			
1	Kawneer Standard		By kawneer			
1	Zero 8198AA	626				
1	Sce 679-05HM/WD		BY OTHERS			
1	Von Duprin PS902 900-2RS		BY OTHERS			
1	Von Duprin EPT 10 CON	689				
	1001 SF #S06 E Kawneer Insulpour 3 601UT stor 601UT Sto QTY/LEAF 1 1 1 1 1 1 1 1 1 1 1 1 1 1 1 1 1 1 1	1001  SF #S06 Entry Vestibule  Kawneer  Insulpour 350T Thermal 2 1/4" doors  601UT storefronts  601UT Storefronts  QTY/LEAF	DOOR OPENING:   SF #S06 Entry Vestibule   LEAVES:   Kawneer   SWING:   Insulpour 350T Thermal 2 1/4" doors   DOOR FINISH:   601UT storefronts   ARCH. HW. SET:   601UT Storefronts	DOOR OPENING: 3'-0"- 7'-10"	1001   DOOR OPENING:   3'-0"- 7'-10"   SF #S06 Entry Vestibule   LEAVES:   Single   SWING:   Outswing   Outswing   DOOR FINISH:   TBD   TBD	DOOR OPENING:   3'-0"- 7'-10"   SF #S06 Entry Vestibule   LEAVES:   Single   Outswing   DOOR FINISH:   TBD   TBD

- 1. COORDINATION OF ACCESS CONTROL, ELECTRIC HARDWARE AND SECURITY SYSTEM BY OTHERS.
- \* FROM BOTTOM OF DOOR TO CENTERLINE OF TOP ATTACHMENT
- \*\* FROM BOTTOM OF DOOR TO CENTERLINE OF PUSH BAR
- \*\*\* FROM BOTTOM OF DOOR TO CENTERLINE CYLINDER

DOOR #:	1001C		QUANTITY:	1	Ī		Т
ARCHITECT'S DOOR #:	1001		DOOR OPENING:	6'-0"x 7'-10"	1	İ	
LOCATION:	SF #S08 I	Entry Vestibule	LEAVES:	~~			
MANUFACTURER:	Kawneer		SWING:	Outswing	Supply		=
DOOR TYPE:	Insulpour 3	350T Thermal 2 1/4" doors	DOOR FINISH:		9	Prep	Install
FRAMING SYSTEM HEAD:	601UT sto	refronts	ARCH. HW. SET:		Ñ	₫	트
FRAMING SYSTEM JAMB:	601UT Sto	refronts		The second section is a second	Ϋ́	X.	اخا
HARDWARE	QTY/LEAF	MANUFACTURER/DESCRIPTION	FINISH	NOTES/DIMENSIONS			
CONT HINGES	1	Ives 112HD-EPT	630				
OVERHEAD STOP	1	GLY 100S	630	Concealed heavy duty			
ACTIVE LEAF EXIT DEVICE	1	Von Duprin RX-QEL 35A-EO	US26D	1/2" INS Kit			ļ
IN-ACTIVE LEAF EXIT DEVICE	1	Von Duprin RX-QEL 35A-NL-OP	US26D	1/2" INS Kit			
RIM CYLINDER	1	Schlage, 7 Pin SFIC (as required)	626	7-7-7-			
MORTISE CYLINDER	1	Schlage, 7 Pin SFIC (as required)	626				
REMOVABLE MULLION	1	VON DUPRIN KR4954	626				
OFFSET PULLS	1	ROCKWOOD RM3310x48"	630				
CLOSER	1	LCN 4040XP EDA	689				
CLOSER DROP PLATES	1	LCN 4040XP-18G	689				*****
WEATHERSTRIPPING	1	Kawneer Standard	N/A	By kawneer			
DOOR CONTACTS	1	Sce 679-05HM/ <b>WD</b>		BY OTHERS			
CARD READER		BY OTHERS		BY OTHERS			
POWER SUPPLY	1	Von Duprin PS902 900-2RS		BY OTHERS			
POWER TRANSFERS	1	Von Duprin EPT 10 CON	689				
NOTES							

- 1. COORDINATION OF ACCESS CONTROL, ELECTRIC HARDWARE AND SECURITY SYSTEM BY OTHERS.
- \* FROM BOTTOM OF DOOR TO CENTERLINE OF TOP ATTACHMENT
- \*\* FROM BOTTOM OF DOOR TO CENTERLINE OF PUSH BAR
- \*\*\* FROM BOTTOM OF DOOR TO CENTERLINE CYLINDER

DOOR #:	1001D		QUANTITY:	1			Т
ARCHITECT'S DOOR #:	1001		DOOR OPENING:	3'-0"- 7'-10"			
LOCATION:	SF #S08 E	ntry Vestibule	LEAVES:	Single	I 🛴		
MANUFACTURER:	Kawneer		SWING:	Outswing	Supply		₩
DOOR TYPE:	Insulpour 3	350T Thermal 2 1/4" doors	DOOR FINISH:	TBD	g	rep	Install
FRAMING SYSTEM HEAD:			ARCH. HW. SET:	9	S	م	<del>-</del>
FRAMING SYSTEM JAMB:	601UT Sto	refronts			×	×	×
HARDWARE	QTY/LEAF	MANUFACTURER/DESCRIPTION	FINISH	NOTES/DIMENSIONS			
CONT HINGES	1	Ives 112HD-EPT	630				
OVERHEAD STOP	1	GLY 100S	630	Concealed heavy duty			
ACTIVE LEAF EXIT DEVICE	1	Von Duprin RX-QEL 35A-NL-OP	626	1/2" INS Kit			
RIM CYLINDER		Schlage, 7 Pin SFIC (as required)	626				
OFFSET PULLS	1	Rockwood RM3310 x 48	630				İ
AUTO OPERATOR	1	LCN 4640 (push side)	689				
WALL ACTUATOR	1	LCN 8310-818T	630				
WEATHERSTRIPPING	1	Kawneer Standard	N/A	By kawneer			
DOOR CONTACTS	1	Sce 679-05HM/WD		BY OTHERS			
CARD READER		BY OTHERS		BY OTHERS			
POWER SUPPLY	1	Von Duprin PS902 900-2RS		BY OTHERS			
POWER TRANSFERS	1	Von Duprin EPT 10 CON	689				

- 1. COORDINATION OF ACCESS CONTROL, ELECTRIC HARDWARE AND SECURITY SYSTEM BY OTHERS.
- \* FROM BOTTOM OF DOOR TO CENTERLINE OF TOP ATTACHMENT
- \*\* FROM BOTTOM OF DOOR TO CENTERLINE OF PUSH BAR
- \*\*\* FROM BOTTOM OF DOOR TO CENTERLINE CYLINDER

DOOR #:	1040A		QUANTITY:	1	<u> </u>		Т
ARCHITECT'S DOOR #:	1040		DOOR OPENING:	3'-0"x 7'-10"			
LOCATION:	SF #W45	STAIR 4	LEAVES:	Single			
MANUFACTURER:	Kawneer		SWING:	outswing	upply		stall
DOOR TYPE:	Insulpour 3	350T Thermal 2 1/4" doors	DOOR FINISH:	TBD	3	rep	ıst
FRAMING SYSTEM HEAD:			ARCH. HW. SET:	16	S	٩.	=
FRAMING SYSTEM JAMB:	601UT Sto	refronts		V	X	¥	¥
HARDWARE	QTY/LEAF	MANUFACTURER/DESCRIPTION	FINISH	NOTES/DIMENSIONS			
CONT HINGES	1	Ives 112HD-EPT	630				
OVERHEAD STOP	1	GLY 100S	630	Concealed heavy duty			
ACTIVE LEAF EXIT DEVICE	1	Von Duprin RX 35A-EO	626	1/2" INS Kit			
CLOSER	1	LCN 4040XP EDA	689				
CLOSER DROP PLATES	1	LCN 4040XP-18G	689				
DRIP CAP	1	Zero 142	626				
THRESHOLD	1	Kawneer Standard		By kawneer			
WEATHERSTRIPPING	1	Kawneer Standard		By kawneer			
DOOR SWEEPS	1	Zero 8198AA	626	***************************************			
DOOR CONTACTS	1	Sce 679-05HM/WD		BY OTHERS			
POWER TRANSFERS	1	Von Duprin EPT 10 CON	689				

- 1. COORDINATION OF ACCESS CONTROL, ELECTRIC HARDWARE AND SECURITY SYSTEM BY OTHERS.
- \* FROM BOTTOM OF DOOR TO CENTERLINE OF TOP ATTACHMENT
- \*\* FROM BOTTOM OF DOOR TO CENTERLINE OF PUSH BAR
- \*\*\* FROM BOTTOM OF DOOR TO CENTERLINE CYLINDER

DOOR #:	1050A		QUANTITY:	1			T
ARCHITECT'S DOOR #:	1050		DOOR OPENING:	6'-0"x 7'-10"			
LOCATION:	SF# LOB	ВҮ	LEAVES:	Pair			
MANUFACTURER:	Kawneer		SWING:	Outswing	Supply		등
DOOR TYPE:	Insulpour 3	350T Thermal 2 1/4" doors	DOOR FINISH:	TBD	유	rep	Install
FRAMING SYSTEM HEAD:			ARCH. HW. SET:	8	S	٩	<del>-</del>
FRAMING SYSTEM JAMB:	601UT Sto	refronts		770	¥	¥	<b>×</b>
HARDWARE	QTY/LEAF	MANUFACTURER/DESCRIPTION	FINISH	NOTES/DIMENSIONS			
CONT HINGES	1	lves 112HD-EPT	630				
OVERHEAD STOP	1	GLY 100S	630	Concealed heavy duty			
ACTIVE LEAF EXIT DEVICE	1	Von Duprin RX-QEL 35A-EO	US26D	1/2" INS Kit			
IN-ACTIVE LEAF EXIT DEVICE	1	Von Duprin RX-QEL 35A-NL-OP	US26D	1/2" INS Kit			
RIM CYLINDER	1	Schlage, 7 Pin SFIC (as required)	626				
MORTISE CYLINDER	1	Schlage, 7 Pin SFIC (as required)	626				
REMOVABLE MULLION	1	VON DUPRIN KR4954	626				
OFFSET PULLS	1	ROCKWOOD RM3310x48"	630				
CLOSER	1	LCN 4040XP EDA	689				
CLOSER DROP PLATES	1	LCN 4040XP-18G	689				
DRIP CAP	1	Zero 142	626	777777			
THRESHOLD	1	Kawneer Standard		By kawneer			
WEATHERSTRIPPING	1	Kawneer Standard		By kawneer			
DOOR SWEEPS	1	Zero 8198AA	626				
DOOR CONTACTS	1	Sce 679-05HM/WD		BY OTHERS			
CARD READER		BY OTHERS		BY OTHERS			
POWER SUPPLY	1	Von Duprin PS902 900-2RS		BY OTHERS			
POWER TRANSFERS	1	Von Duprin EPT 10 CON	689				

- 1. COORDINATION OF ACCESS CONTROL, ELECTRIC HARDWARE AND SECURITY SYSTEM BY OTHERS.
- \* FROM BOTTOM OF DOOR TO CENTERLINE OF TOP ATTACHMENT
- \*\* FROM BOTTOM OF DOOR TO CENTERLINE OF PUSH BAR
- \*\*\* FROM BOTTOM OF DOOR TO CENTERLINE CYLINDER

DOOR #:	1050B		QUANTITY:	11	T		Г
ARCHITECT'S DOOR #:	1050		DOOR OPENING:	3'-0"- 7'-10"			
LOCATION:	SF # LOBI	BY	LEAVES:				l
MANUFACTURER:	Kawneer	V VVALORE IN THE SECOND		Outswing	hddn	۱.	=
DOOR TYPE:	Insulpour 3	350T Thermal 2 1/4" doors	DOOR FINISH:	<u> </u>	ᅙ	e e	Install
FRAMING SYSTEM HEAD:			ARCH. HW. SET:		ଊ	<u>~</u>	므
FRAMING SYSTEM JAMB:	601UT Sto	refronts			~	Ϋ́	7
HARDWARE	QTY/LEAF	MANUFACTURER/DESCRIPTION	FINISH	NOTES/DIMENSIONS			
CONT HINGES	1	Ives 112HD-EPT	630				
OVERHEAD STOP	1	GLY 100S	630	Concealed heavy duty			
ACTIVE LEAF EXIT DEVICE	1	Von Duprin RX-QEL 35A-NL-OP	626	1/2" INS Kit			
RIM CYLINDER	7.	Schlage, 7 Pin SFIC (as required)	626	V 10-10-10-10-10-10-10-10-10-10-10-10-10-1			
OFFSET PULLS	1	Rockwood RM3310 x 48	630	· · · · · · · · · · · · · · · · · · ·			
AUTO OPERATOR	1	LCN 4640 (push side)	689				
WALL ACTUATOR	1	LCN 8310-818T	630				
WALL ACTUATOR	1	LCN 8310-855 (Vestibule)	630			************	
DRIP CAP		Zero 142	626				
THRESHOLD	1	Kawneer Standard		Ву кампеег			
WEATHERSTRIPPING	1	Kawneer Standard		By kawneer			
DOOR SWEEPS	1	Zero 8198AA	626				
DOOR CONTACTS	1	Sce 679-05HM/WD		BY OTHERS		Ī	
POWER SUPPLY	1	Von Duprin PS902 900-2RS		BY OTHERS			
POWER TRANSFERS	1	Von Duprin EPT 10 CON	689				

- 1. COORDINATION OF ACCESS CONTROL, ELECTRIC HARDWARE AND SECURITY SYSTEM BY OTHERS.
- \* FROM BOTTOM OF DOOR TO CENTERLINE OF TOP ATTACHMENT
- \*\* FROM BOTTOM OF DOOR TO CENTERLINE OF PUSH BAR
- \*\*\* FROM BOTTOM OF DOOR TO CENTERLINE CYLINDER

		QUANTITY:	1			
1050		DOOR OPENING:	6'-0"x 7'-10 15/16"			
SF #W15	LOBBY	LEAVES:	Pair	_		
Kawneer		SWING:	Outswing	pl	^	stall
Insulpour 3	350T Thermal 2 1/4" doors			dn	ē	St
601UT stor	refronts	ARCH. HW. SET:	11	S	٠	=
601UT Sto	refronts		770.00	노	Ÿ	یا ا
QTY/LEAF	MANUFACTURER/DESCRIPTION	FINISH	NOTES/DIMENSIONS			
1	Ives 112HD-EPT	630				
1	GLY 100S	630	Concealed heavy duty			
1	Von Duprin RX-QEL 35A-EO	US26D	1/2" INS Kit			
1	Von Duprin RX-QEL 35A-NL-OP	US26D	1/2" INS Kit	ı		
1	Schlage, 7 Pin SFIC (as required)	626	***************************************			·
1	Schlage, 7 Pin SFIC (as required)	626			******	
1	VON DUPRIN KR4954	626				
1	ROCKWOOD RM3310x48"	630				
1	LCN 4040XP EDA	689				
1	LCN 4040XP-18G	689	· · · · · · · · · · · · · · · · · · ·	Ť		
1	Kawneer Standard	N/A	By kawneer			
1	Sce 679-05HM/WD		*****			
	BY OTHERS		BY OTHERS			
1	Von Duprin PS902 900-2RS		BY OTHERS			
1	Von Duprin EPT 10 CON	689				
	Kawneer Insulpour 3 601UT stor 601UT Stor 01UT Stor 1 1 1 1 1 1 1 1 1 1 1 1 1 1 1 1 1 1 1	Insulpour 350T Thermal 2 1/4" doors 601UT storefronts 601UT Storefronts  QTY/LEAF MANUFACTURER/DESCRIPTION  1 Ives 112HD-EPT 1 GLY 100S 1 Von Duprin RX-QEL 35A-EO 1 Von Duprin RX-QEL 35A-NL-OP 1 Schlage, 7 Pin SFIC (as required) 1 Schlage, 7 Pin SFIC (as required) 1 VON DUPRIN KR4954 1 ROCKWOOD RM3310x48" 1 LCN 4040XP EDA 1 LCN 4040XP-18G	Kawneer         SWING:           Insulpour 350T Thermal 2 1/4" doors         DOOR FINISH:           601UT storefronts         ARCH. HW. SET:           601UT Storefronts         ARCH. HW. SET:           QTY/LEAF         MANUFACTURER/DESCRIPTION         FINISH           1         Ives 112HD-EPT         630           1         GLY 100S         630           1         Von Duprin RX-QEL 35A-EO         US26D           1         Von Duprin RX-QEL 35A-NL-OP         US26D           1         Schlage, 7 Pin SFIC (as required)         626           1         Schlage, 7 Pin SFIC (as required)         626           1         VON DUPRIN KR4954         626           1         ROCKWOOD RM3310x48"         630           1         LCN 4040XP EDA         689           1         LCN 4040XP-18G         689           1         Kawneer Standard         N/A           1         Sce 679-05HM/WD         N/A           BY OTHERS         1         Von Duprin PS902 900-2RS	Swing   Swing   Door Finish   TBD	Swing   Outswing   Door Finish   TBD   TBD   Swing   Swing   TBD   Name	

- 1. COORDINATION OF ACCESS CONTROL, ELECTRIC HARDWARE AND SECURITY SYSTEM BY OTHERS.
- \* FROM BOTTOM OF DOOR TO CENTERLINE OF TOP ATTACHMENT
- \*\* FROM BOTTOM OF DOOR TO CENTERLINE OF PUSH BAR
- \*\*\* FROM BOTTOM OF DOOR TO CENTERLINE CYLINDER

DOOR #:	1050D		QUANTITY:	1	T		Т
ARCHITECT'S DOOR #:	1050	V/ = 11	DOOR OPENING:	3'-0"- 7'-10 15/16"		l	
LOCATION:	SF #W15 I	LOBBY	LEAVES:	Single		1	
MANUFACTURER:	Kawneer		SWING:	Outswing	upply	0	등
DOOR TYPE:	Insulpour 3	350T Thermal 2 1/4" doors	DOOR FINISH:	TBD	dn	rep	Install
FRAMING SYSTEM HEAD:			ARCH. HW. SET:	9	S	Α.	투
FRAMING SYSTEM JAMB:	601UT Sto	refronts			노	K.	×
HARDWARE	QTY/LEAF	MANUFACTURER/DESCRIPTION	FINISH	NOTES/DIMENSIONS			
CONT HINGES	1	Ives 112HD-EPT	630				
OVERHEAD STOP	1	GLY 100S	630	Concealed heavy duty			
ACTIVE LEAF EXIT DEVICE	1	Von Duprin RX-QEL 35A-NL-OP	626	1/2" INS Kit			
RIM CYLINDER		Schlage, 7 Pin SFIC (as required)	626	V-9-VILL-2-1			
OFFSET PULLS	1	Rockwood RM3310 x 48	630				í
AUTO OPERATOR	1	LCN 4640 (push side)	689				
WALL ACTUATOR	1	LCN 8310-818T	630	V-0-1-1-1-1-1-1-1-1-1-1-1-1-1-1-1-1-1-1-			
WEATHERSTRIPPING	1	Kawneer Standard	N/A	By kawneer			
DOOR CONTACTS	1	Sce 679-05HM/WD		BY OTHERS			
CARD READER		BY OTHERS		BY OTHERS			
POWER SUPPLY	1	Von Duprin PS902 900-2RS		BY OTHERS			
POWER TRANSFERS	1	Von Duprin EPT 10 CON	689				

- 1. COORDINATION OF ACCESS CONTROL, ELECTRIC HARDWARE AND SECURITY SYSTEM BY OTHERS.
- \* FROM BOTTOM OF DOOR TO CENTERLINE OF TOP ATTACHMENT
- \*\* FROM BOTTOM OF DOOR TO CENTERLINE OF PUSH BAR
- \*\*\* FROM BOTTOM OF DOOR TO CENTERLINE CYLINDER

DOOR #	: 1328A		QUANTITY:	1	Г		П
ARCHITECT'S DOOR #	1328		DOOR OPENING:	3'-0"x 7'-10"			
LOCATION	SF #W01	BAND/CHORUS	LEAVES:	Single			
MANUFACTURER	Kawneer		SWING:	outswing	Supply		nstall
DOOR TYPE	Insulpour 3	350T Thermal 2 1/4" doors	DOOR FINISH:	TBD	g	Prep	St
FRAMING SYSTEM HEAD	601UT sto	refronts	ARCH. HW. SET:	16	ွ	٩	투
FRAMING SYSTEM JAMB	601UT Sto	refronts			포	¥	¥
HARDWARE	QTY/LEAF	MANUFACTURER/DESCRIPTION	FINISH	NOTES/DIMENSIONS			T
CONT HINGES	1	Ives 112HD-EPT	630				1
OVERHEAD STOP	1	GLY 100S	630	Concealed heavy duty			1
ACTIVE LEAF EXIT DEVICE	1	Von Duprin RX 35A-EO	626	1/2" INS Kit			
CLOSER	1	LCN 4040XP EDA	689				<u> </u>
CLOSER DROP PLATES	1	LCN 4040XP-18G	689				ļ
DRIP CAP	1	Zero 142	626				
THRESHOLD	1	Kawneer Standard		By kawneer			
WEATHERSTRIPPING	1	Kawneer Standard		By kawneer			· · · · · · ·
DOOR SWEEPS	1	Zero 8198AA	626				
DOOR CONTACTS	1	Sce 679-05HM/WD		BY OTHERS			ļ
POWER TRANSFERS	1	Von Duprin EPT 10 CON	689				

- 1. COORDINATION OF ACCESS CONTROL, ELECTRIC HARDWARE AND SECURITY SYSTEM BY OTHERS.
- \* FROM BOTTOM OF DOOR TO CENTERLINE OF TOP ATTACHMENT
- \*\* FROM BOTTOM OF DOOR TO CENTERLINE OF PUSH BAR
- \*\*\* FROM BOTTOM OF DOOR TO CENTERLINE CYLINDER
- \*\* FROM BOTTOM OF DOOR TO CENTERLINE OF PUSH BAR
- \*\*\* FROM BOTTOM OF DOOR TO CENTERLINE CYLINDER

DOOR #:	1550A		QUANTITY:	1			
ARCHITECT'S DOOR #:	1550		DOOR OPENING:	3'-0"x 7'-10"			
LOCATION:	SF# CAF	ETERIA	LEAVES:	Single	I		
MANUFACTURER:	Kawneer		SWING:	outswing	Supply		stall
DOOR TYPE:	Insulpour 3	350T Thermal 2 1/4" doors	DOOR FINISH:	TBD	п	Prep	St
FRAMING SYSTEM HEAD:	601UT sto	refronts	ARCH. HW. SET:	2	S.	٠	L.
FRAMING SYSTEM JAMB:	601UT Sto	refronts			¥	¥	<b>×</b>
HARDWARE	QTY/LEAF	MANUFACTURER/DESCRIPTION	FINISH	NOTES/DIMENSIONS			
CONT HINGES	1	Ives 112HD-EPT	630				
OVERHEAD STOP	1	GLY 100S	630	Concealed heavy duty			
ACTIVE LEAF EXIT DEVICE	1	Von Duprin LD-RX-98-NL-OP	626	1/2" INS Kit			
RIM CYLINDER		Schlage, 7 Pin SFIC (as required)	626				
OFFSET PULLS	1	IVES 8190-0 10"	630	1,101			
CLOSER	1	LCN 4040XP SCUSH	689				
CLOSER DROP PLATES	1	LCN 4040XP-18G	689				
DRIP CAP	1	Zero 142	626				
THRESHOLD	1	Kawneer Standard		By kawneer			
WEATHERSTRIPPING	1	Kawneer Standard		By kawneer			
DOOR SWEEPS	1	Zero 8198AA	626				
DOOR CONTACTS	1	Sce 679-05HM/WD		BY OTHERS			
POWER SUPPLY	1	Von Duprin PS902 900-2RS		BY OTHERS			
POWER TRANSFERS	1	Von Duprin EPT 10 CON	689			$\neg$	$\neg$

- 1. COORDINATION OF ACCESS CONTROL, ELECTRIC HARDWARE AND SECURITY SYSTEM BY OTHERS.
- \* FROM BOTTOM OF DOOR TO CENTERLINE OF TOP ATTACHMENT
- \*\* FROM BOTTOM OF DOOR TO CENTERLINE OF PUSH BAR
- \*\*\* FROM BOTTOM OF DOOR TO CENTERLINE CYLINDER

DOOR #:	1550B		QUANTITY:	1	Г		T
ARCHITECT'S DOOR #:	1550	777 A 1 1 1 1 1 1 1 1 1 1 1 1 1 1 1 1 1	DOOR OPENING:	3'-0"x 7'-10"			1
LOCATION:	SF # CAF	ETERIA	LEAVES:	Single	_		
MANUFACTURER:	Kawneer		SWING:	outswing	Supply		Install
DOOR TYPE:	Insulpour 3	350T Thermal 2 1/4" doors	DOOR FINISH:	TBD	ᆿ	rep	ıst
FRAMING SYSTEM HEAD:	601UT stor	refronts	ARCH. HW. SET:	2	S-	д-	<del>-</del>
FRAMING SYSTEM JAMB:	601UT Sto	refronts			¥	¥	노
HARDWARE	QTY/LEAF	MANUFACTURER/DESCRIPTION	FINISH	NOTES/DIMENSIONS			
CONT HINGES	1	Ives 112HD-EPT	630				
OVERHEAD STOP	1	GLY 100S	630	Concealed heavy duty		J.72.12614160	
ACTIVE LEAF EXIT DEVICE	1	Von Duprin LD-RX-98-NL-OP	626	1/2" INS Kit			
RIM CYLINDER		Schlage, 7 Pin SFIC (as required)	626				
OFFSET PULLS	1	IVES 8190-0 10"	630				
CLOSER	1	LCN 4040XP SCUSH	689				
CLOSER DROP PLATES	1	LCN 4040XP-18G	689				
DRIP CAP	1	Zero 142	626	V 200			
THRESHOLD	1	Kawneer Standard		By kawneer			
WEATHERSTRIPPING	1	Kawneer Standard		By kawneer			
DOOR SWEEPS	1	Zero 8198AA	626				
DOOR CONTACTS	1	Sce 679-05HM/WD		BY OTHERS			
POWER SUPPLY	1	Von Duprin PS902 900-2RS		BY OTHERS	<u> </u>		
POWER TRANSFERS	1	Von Duprin EPT 10 CON	689				

- 1. COORDINATION OF ACCESS CONTROL, ELECTRIC HARDWARE AND SECURITY SYSTEM BY OTHERS.
- \* FROM BOTTOM OF DOOR TO CENTERLINE OF TOP ATTACHMENT
- \*\* FROM BOTTOM OF DOOR TO CENTERLINE OF PUSH BAR
- \*\*\* FROM BOTTOM OF DOOR TO CENTERLINE CYLINDER

DOOR #:	1550C		QUANTITY:	1	T		Г
ARCHITECT'S DOOR #:	1550	VALLE	DOOR OPENING:		i		
LOCATION:		ETERIA	LEAVES:				
MANUFACTURER:				outswing	🎽	İ	=
		350T Thermal 2 1/4" doors	DOOR FINISH:		Supply	Prep	Install
FRAMING SYSTEM HEAD:			ARCH. HW. SET:		જ	4	ا تا
FRAMING SYSTEM JAMB:			AROTI, IIV. OL J.	_	X -	Ϋ́	ᅶ
HARDWARE	QTY/LEAF	MANUFACTURER/DESCRIPTION	FINISH	NOTES/DIMENSIONS			
CONT HINGES	1	Ives 112HD-EPT	630				
OVERHEAD STOP	1	GLY 100S	630	Concealed heavy duty			
ACTIVE LEAF EXIT DEVICE	1	Von Duprin LD-RX-98-NL-OP	626	1/2" INS Kit			# TOT
RIM CYLINDER		Schlage, 7 Pin SFIC (as required)	626		-1-1		
OFFSET PULLS	1	IVES 8190-0 10"	630				
CLOSER	1	LCN 4040XP SCUSH	689	France Co.			
CLOSER DROP PLATES	1	LCN 4040XP-18G	689				
DRIP CAP	1	Zero 142	626				
THRESHOLD	1	Kawneer Standard		By kawneer			
WEATHERSTRIPPING	1	Kawneer Standard		By kawneer	1		
DOOR SWEEPS	1	Zero 8198AA	626				
DOOR CONTACTS	1	Sce 679-05HM/WD		BY OTHERS			
POWER SUPPLY	1	Von Duprin PS902 900-2RS		BY OTHERS			
POWER TRANSFERS	1	Von Duprin EPT 10 CON	689	Water Control of the		$\neg$	$\neg$

- 1. COORDINATION OF ACCESS CONTROL, ELECTRIC HARDWARE AND SECURITY SYSTEM BY OTHERS.
- \* FROM BOTTOM OF DOOR TO CENTERLINE OF TOP ATTACHMENT
- \*\* FROM BOTTOM OF DOOR TO CENTERLINE OF PUSH BAR
- \*\*\* FROM BOTTOM OF DOOR TO CENTERLINE CYLINDER

DOOR #:	1600A		QUANTITY:	11			
ARCHITECT'S DOOR #:	1600		DOOR OPENING:			ĺ	
LOCATION:	SF #W17	FABLAB/TECH	LEAVES:				
MANUFACTURER:	Kawneer		SWING:	outswing	Supply		=
DOOR TYPE:	Insulpour 3	350T Thermal 2 1/4" doors	DOOR FINISH:		dn	Prep	Install
FRAMING SYSTEM HEAD:			ARCH. HW. SET:	2	Š	颪	드
FRAMING SYSTEM JAMB:	601UT Sto	refronts	F1-10-1	7.4-1-1-1-1-1-1-1-1-1-1-1-1-1-1-1-1-1-1-1	Α.	X.	¥
HARDWARE	QTY/LEAF	MANUFACTURER/DESCRIPTION	FINISH	NOTES/DIMENSIONS			
CONT HINGES	1	Ives 112HD-EPT	630				
OVERHEAD STOP	1	GLY 100S	630	Concealed heavy duty			
ACTIVE LEAF EXIT DEVICE	1	Von Duprin LD-RX-98-NL-OP	626	1/2" INS Kit			
RIM CYLINDER		Schlage, 7 Pin SFIC (as required)	626				
OFFSET PULLS	1	IVES 8190-0 10"	630				
CLOSER	1	LCN 4040XP SCUSH	689	- And where			
CLOSER DROP PLATES	1	LCN 4040XP-18G	689				
DRIP CAP	1	Zero 142	626				
THRESHOLD	1	Kawneer Standard		By kawneer			
WEATHERSTRIPPING	1	Kawneer Standard		By kawneer			
DOOR SWEEPS	1	Zero 8198AA	626	ME MANAGES AT 10/100			
DOOR CONTACTS	1	Sce 679-05HM/WD		BY OTHERS			
POWER SUPPLY	1	Von Duprin PS902 900-2RS		BY OTHERS			
POWER TRANSFERS	1	Von Duprin EPT 10 CON	689	All many and the second		$\neg$	$\dashv$

- 1. COORDINATION OF ACCESS CONTROL, ELECTRIC HARDWARE AND SECURITY SYSTEM BY OTHERS.
- \* FROM BOTTOM OF DOOR TO CENTERLINE OF TOP ATTACHMENT
- \*\* FROM BOTTOM OF DOOR TO CENTERLINE OF PUSH BAR
- \*\*\* FROM BOTTOM OF DOOR TO CENTERLINE CYLINDER

DOOR #:	1680A		QUANTITY:	1			T
ARCHITECT'S DOOR #:	1680		DOOR OPENING:		1	ł	1
LOCATION:	SF #W19	MAKERSPACE/SHOP	LEAVES:		_		
MANUFACTURER:	Kawneer			outswing	npply		≡
DOOR TYPE:	Insulpour 3	350T Thermal 2 1/4" doors	DOOR FINISH:	<del></del>	ਕੋ	rep	stall
FRAMING SYSTEM HEAD:		TTYPEPUNCTURE TO THE TOTAL TO THE TOTAL TO	ARCH. HW. SET:		ิซ	₫	드
FRAMING SYSTEM JAMB:	601UT Sto	refronts		New York	Α.	Ϋ́	7
HARDWARE	QTY/LEAF	MANUFACTURER/DESCRIPTION	FINISH	NOTES/DIMENSIONS			Ħ
CONT HINGES	1	lves 112HD-EPT	630				l
OVERHEAD STOP	1	GLY 100S	630	Concealed heavy duty			
ACTIVE LEAF EXIT DEVICE	1	Von Duprin RX-QEL 35A-EO	US26D	1/2" INS Kit			
IN-ACTIVE LEAF EXIT DEVICE	1	Von Duprin RX-QEL 35A-NL-OP	US26D	1/2" INS Kit			l
RIM CYLINDER	1	Schlage, 7 Pin SFIC (as required)	626				
MORTISE CYLINDER	1	Schlage, 7 Pin SFIC (as required)	626				
REMOVABLE MULLION	1	VON DUPRIN KR4954	626				
OFFSET PULLS	1	ROCKWOOD RM3310x48"	630				
CLOSER	1	LCN 4040XP EDA	689				
CLOSER DROP PLATES	1	LCN 4040XP-18G	689				
DRIP CAP	1	Zero 142	626				
THRESHOLD	1	Kawneer Standard		By kawneer			
WEATHERSTRIPPING	1	Kawneer Standard		By kawneer			
DOOR SWEEPS	1	Zero 8198AA	626	-			
DOOR CONTACTS	1	Sce 679-05HM/WD		BY OTHERS		$\dashv$	

- 1. COORDINATION OF ACCESS CONTROL, ELECTRIC HARDWARE AND SECURITY SYSTEM BY OTHERS.
- \* FROM BOTTOM OF DOOR TO CENTERLINE OF TOP ATTACHMENT
- \*\* FROM BOTTOM OF DOOR TO CENTERLINE OF PUSH BAR
- \*\*\* FROM BOTTOM OF DOOR TO CENTERLINE CYLINDER

DOOR #:	2070A		QUANTITY:	1	Ĭ		T
ARCHITECT'S DOOR #:	2070		DOOR OPENING:	3'-0"x 7'-10"		ĺ	1
LOCATION:	SF #E36 S	STAIR 7	LEAVES:	Single			
MANUFACTURER:	Kawneer		SWING:	outswing	upply	_	stall
DOOR TYPE:	Insulpour 3	350T Thermal 2 1/4" doors	DOOR FINISH:		유	rep	St
FRAMING SYSTEM HEAD:	601UT sto	refronts	ARCH. HW. SET:	16	Ś	<u>-</u>	트
FRAMING SYSTEM JAMB:	601UT Sto	refronts			×	7	<u>\</u>
HARDWARE	QTY/LEAF	MANUFACTURER/DESCRIPTION	FINISH	NOTES/DIMENSIONS			
CONT HINGES	1	Ives 112HD-EPT	630				
OVERHEAD STOP	1	GLY 100S	630	Concealed heavy duty			
ACTIVE LEAF EXIT DEVICE	1	Von Duprin RX 35A-EO	626	1/2" INS Kit			İ
CLOSER	1	LCN 4040XP EDA	689				
CLOSER DROP PLATES	1	LCN 4040XP-18G	689	year-			
DRIP CAP	1	Zero 142	626				
THRESHOLD	1	Kawneer Standard		By kawneer			
WEATHERSTRIPPING	1	Kawneer Standard		By kawneer			
DOOR SWEEPS	1	Zero 8198AA	626				
DOOR CONTACTS	1	Sce 679-05HM/WD		BY OTHERS			
POWER TRANSFERS	1	Von Duprin EPT 10 CON	689	ANTP-A			ļ

- 1. COORDINATION OF ACCESS CONTROL, ELECTRIC HARDWARE AND SECURITY SYSTEM BY OTHERS.
- \* FROM BOTTOM OF DOOR TO CENTERLINE OF TOP ATTACHMENT
- \*\* FROM BOTTOM OF DOOR TO CENTERLINE OF PUSH BAR
- \*\*\* FROM BOTTOM OF DOOR TO CENTERLINE CYLINDER

DOOR #:	2075A		QUANTITY:	1	Γ		
ARCHITECT'S DOOR #:	2075		DOOR OPENING:	3'-0"x 7'-8"			
LOCATION:	SF #E37	VESTIBULE	LEAVES:	Single			
MANUFACTURER:	Kawneer		SWING:	outswing	든		=
DOOR TYPE:	Insulpour 3	350T Thermal 2 1/4" doors	DOOR FINISH:	TBD	Supply	Prep	Install
FRAMING SYSTEM HEAD:	601UT sto	refronts	ARCH. HW. SET:	1	S	٠.	<del>-</del>
FRAMING SYSTEM JAMB:	601UT Sto	refronts			¥	¥	×
HARDWARE	QTY/LEAF	MANUFACTURER/DESCRIPTION	FINISH	NOTES/DIMENSIONS			
CONT HINGES	1	lves 112HD-EPT	630				
OVERHEAD STOP	1	GLY 100S	630	Concealed heavy duty			
ACTIVE LEAF EXIT DEVICE	1	Von Duprin RX-QEL 35A-NL-OP	626	1/2" INS Kit			
RIM CYLINDER		Schlage, 7 Pin SFIC (as required)	626				
OFFSET PULLS	1	Rockwood RM3310 x 48	630				
AUTO OPERATOR	1	LCN 4640 (push side)	689				
WALL ACTUATOR	1	LCN 8310-818T	630				
WALL ACTUATOR	1	LCN 8310-855 (Vestibule)	630	71.			
DRIP CAP	1	Zero 142	626	2/			
THRESHOLD	1	Kawneer Standard	TO SEA IN LITTLE TO A COUNT OF INSTITUTE OF	By kawneer			
WEATHERSTRIPPING	1	Kawneer Standard		By kawneer			
DOOR SWEEPS	1	Zero 8198AA	626		1		
DOOR CONTACTS	1	Sce 679-05HM/WD	The second secon	BY OTHERS			
POWER SUPPLY	1	Von Duprin PS902 900-2RS		BY OTHERS			
POWER TRANSFERS	1	Von Duprin EPT 10 CON	689				

- 1. COORDINATION OF ACCESS CONTROL, ELECTRIC HARDWARE AND SECURITY SYSTEM BY OTHERS.
- \* FROM BOTTOM OF DOOR TO CENTERLINE OF TOP ATTACHMENT
- \*\* FROM BOTTOM OF DOOR TO CENTERLINE OF PUSH BAR
- \*\*\* FROM BOTTOM OF DOOR TO CENTERLINE CYLINDER

DOOR #:	2085		QUANTITY:	1	П		Т
ARCHITECT'S DOOR #:	2085		DOOR OPENING:	3'-0"x 7'-10"	1	l	
LOCATION:	SF #E41 \	VESTIBULE	LEAVES:	Single	١.,		
MANUFACTURER:	Kawneer		SWING:	outswing	Supply		tall
DOOR TYPE:	Insulpour 3	350T Thermal 2 1/4" doors	DOOR FINISH:	TBD	<b> </b>	Prep	ıst
FRAMING SYSTEM HEAD:	601UT sto	refronts	ARCH. HW. SET:	12	လ	<u>-</u> -	<del>-</del>
FRAMING SYSTEM JAMB:	601UT Sto	refronts			¥	¥	×
HARDWARE	QTY/LEAF	MANUFACTURER/DESCRIPTION	FINISH	NOTES/DIMENSIONS			
CONT HINGES	1	Ives 112HD-EPT	630				
OVERHEAD STOP	1	GLY 100S	630	Concealed heavy duty			
ACTIVE LEAF EXIT DEVICE	1	Von Duprin CD-98-L-NL-06	626	1/2" INS Kit			
RIM CYLINDER		Schlage, 7 Pin SFIC (as required)	626				
CLOSER	1	LCN 4040XP SCUSH	689				
CLOSER DROP PLATES	1	LCN 4040XP-18G	689				
WEATHERSTRIPPING	1	Kawneer Standard		By kawneer			

- 1. COORDINATION OF ACCESS CONTROL, ELECTRIC HARDWARE AND SECURITY SYSTEM BY OTHERS.
- \* FROM BOTTOM OF DOOR TO CENTERLINE OF TOP ATTACHMENT
- \*\* FROM BOTTOM OF DOOR TO CENTERLINE OF PUSH BAR
- \*\*\* FROM BOTTOM OF DOOR TO CENTERLINE CYLINDER

DOOR #:	2085A		QUANTITY:	1	T		
ARCHITECT'S DOOR #:	2085		DOOR OPENING:		1		
LOCATION:	SF #E42 \	/ESTIBULE	LEAVES:	Single			
MANUFACTURER:	Kawneer		SWING:	outswing	Supply		震
DOOR TYPE:	Insulpour 3	350T Thermal 2 1/4" doors	DOOR FINISH:		유	Prep	Install
FRAMING SYSTEM HEAD:	601UT sto	refronts	ARCH. HW. SET:	3	S	۵.	트
FRAMING SYSTEM JAMB:	601UT Sto	refronts			٠	Υ <u>Υ</u>	×
HARDWARE	QTY/LEAF	MANUFACTURER/DESCRIPTION	FINISH	NOTES/DIMENSIONS			
CONT HINGES	1	Ives 112HD-EPT	630				
OVERHEAD STOP	1	GLY 100S	630	Concealed heavy duty			
ACTIVE LEAF EXIT DEVICE	1	Von Duprin LD-RX-98-NL-OP-110MD-ALK-WH	626	1/2" INS Kit			i
RIM CYLINDER		Schlage, 7 Pin SFIC (as required)	626	V 7 (A)			[
MORTISE CYLINDER	1	Schlage, 7 Pin SFIC (as required)	626				
OFFSET PULLS	1	IVES 8190-0 10"	630		promonen en en en en en		
CLOSER	1	LCN 4040XP SCUSH	689				
CLOSER DROP PLATES	1	LCN 4040XP-18G	689	777			
DRIP CAP	1	Zero 142	626			-1-0-01-0-1-0-0	
THRESHOLD	1	Kawneer Standard		By kawneer			
WEATHERSTRIPPING	1	Kawneer Standard		By kawneer			
DOOR SWEEPS	1	Zero 8198AA	626				
DOOR CONTACTS	1	Sce 679-05HM/WD		BY OTHERS			
CARD READER		BY OTHERS		BY OTHERS			West and the second
POWER SUPPLY	1	Von Duprin PS902 900-2RS		BY OTHERS			
POWER TRANSFERS	1	Von Duprin EPT 10 CON	689	79.00			

- 1. COORDINATION OF ACCESS CONTROL, ELECTRIC HARDWARE AND SECURITY SYSTEM BY OTHERS.
- \* FROM BOTTOM OF DOOR TO CENTERLINE OF TOP ATTACHMENT
- \*\* FROM BOTTOM OF DOOR TO CENTERLINE OF PUSH BAR
- \*\*\* FROM BOTTOM OF DOOR TO CENTERLINE CYLINDER

DOOR #:	2535A		QUANTITY:	1	Г-	<u> </u>	T
ARCHITECT'S DOOR #:	ļ		DOOR OPENING:	***************************************			
LOCATION:	SF #W33	PROJECT TERRACE	LEAVES:		١.		
MANUFACTURER:	Kawneer	The state of the s		outswing	Supply	۱ ـ	₩
DOOR TYPE:	Insulpour 3	350T Thermal 2 1/4" doors	DOOR FINISH:	<u> </u>	ᅙ	Prep	Install
FRAMING SYSTEM HEAD:			ARCH, HW. SET:	7	Ñ	<u>-</u>	드
FRAMING SYSTEM JAMB:	601UT Sto	refronts			소	7	ᅶ
HARDWARE	QTY/LEAF	MANUFACTURER/DESCRIPTION	FINISH	NOTES/DIMENSIONS			
CONT HINGES	1	Ives 112HD-EPT	630				
OVERHEAD STOP	1	GLY 100S	630	Concealed heavy duty			
ACTIVE LEAF EXIT DEVICE	1	Von Duprin RX-QEL 35A-EO	US26D	1/2" INS Kit			
IN-ACTIVE LEAF EXIT DEVICE	1	Von Duprin RX-QEL 35A-NL-OP	US26D	1/2" INS Kit			
RIM CYLINDER	1	Schlage, 7 Pin SFIC (as required)	626				
MORTISE CYLINDER	1	Schlage, 7 Pin SFIC (as required)	626				
REMOVABLE MULLION	1	VON DUPRIN KR4954	626				
OFFSET PULLS	1	ROCKWOOD RM3310x48"	630				
CLOSER	1	LCN 4040XP EDA	689				
CLOSER DROP PLATES	1	LCN 4040XP-18G	689				
DRIP CAP	1	Zero 142	626	V-4			
THRESHOLD	1	Kawneer Standard	N. C.	By kawneer			
WEATHERSTRIPPING	1	Kawneer Standard		By kawneer			
DOOR SWEEPS	1	Zero 8198AA	626				
DOOR CONTACTS	1	Sce 679-05HM/WD		BY OTHERS			

#### <u>NOTES</u>

- 1. COORDINATION OF ACCESS CONTROL, ELECTRIC HARDWARE AND SECURITY SYSTEM BY OTHERS.
- \* FROM BOTTOM OF DOOR TO CENTERLINE OF TOP ATTACHMENT
- \*\* FROM BOTTOM OF DOOR TO CENTERLINE OF PUSH BAR
- \*\*\* FROM BOTTOM OF DOOR TO CENTERLINE CYLINDER

2535B		QUANTITY:	1	<u> </u>		T
2535		DOOR OPENING:	3'-0"x 7'-10 "	Ī		
SF #W35	PROJECT TERRACE	LEAVES:	SINGLE	1		
Kawneer		SWING:	outswing	1	_	등
Insulpour 3	350T Thermal 2 1/4" doors			유	ē	stall
601UT sto	refronts	ARCH. HW. SET:	7	Ś	Δ.	트
601UT Sto	refronts	* ************************************	The second secon	Ϋ́	Ÿ	<del> </del>
QTY/LEAF	MANUFACTURER/DESCRIPTION	FINISH	NOTES/DIMENSIONS			
1	Ives 112HD-EPT	630				
1	GLY 100S	630	Concealed heavy duty			
1	Von Duprin RX-QEL 35A-EO	US26D	1/2" INS Kit			
1	Von Duprin RX-QEL 35A-NL-OP	US26D	1/2" INS Kit			
1	Schlage, 7 Pin SFIC (as required)	626				
1	Schlage, 7 Pin SFIC (as required)	626				
1	VON DUPRIN KR4954	626				
1	ROCKWOOD RM3310x48"	630				
1	LCN 4040XP EDA	689				
1	LCN 4040XP-18G	689				P*************************************
1	Zero 142	626				
1	Kawneer Standard		By kawneer			
1	Kawneer Standard					
1	Zero 8198AA	626				$\dashv$
1	Sce 679-05HM/WD	70.00	BY OTHERS			
	2535 SF #W35 Kawneer Insulpour 3 601UT stor 601UT Stor 01UT Stor 1 1 1 1 1 1 1 1 1 1 1 1 1 1 1 1 1 1 1	2535  SF #W35 PROJECT TERRACE  Kawneer Insulpour 350T Thermal 2 1/4" doors 601UT storefronts 601UT Storefronts  QTY/LEAF MANUFACTURER/DESCRIPTION  1 Ives 112HD-EPT 1 GLY 100S 1 Von Duprin RX-QEL 35A-EO 1 Von Duprin RX-QEL 35A-NL-OP 1 Schlage, 7 Pin SFIC (as required) 1 Schlage, 7 Pin SFIC (as required) 1 VON DUPRIN KR4954 1 ROCKWOOD RM3310x48"	2535         DOOR OPENING:           SF #W35 PROJECT TERRACE         LEAVES:           Kawneer         SWING:           Insulpour 350T Thermal 2 1/4" doors         DOOR FINISH:           601UT storefronts         ARCH. HW. SET:           601UT Storefronts         FINISH           1         Ives 112HD-EPT         630           1         GLY 100S         630           1         Von Duprin RX-QEL 35A-EO         US26D           1         Von Duprin RX-QEL 35A-NL-OP         US26D           1         Schlage, 7 Pin SFIC (as required)         626           1         Schlage, 7 Pin SFIC (as required)         626           1         VON DUPRIN KR4954         626           1         ROCKWOOD RM3310x48"         630           1         LCN 4040XP EDA         689           1         LCN 4040XP-18G         689           1         Zero 142         626           1         Kawneer Standard         Kawneer Standard           1         Zero 8198AA         626	2535   DOOR OPENING:   3'-0"x 7'-10 "     SF #W35 PROJECT TERRACE   LEAVES: SINGLE     Kawneer   SWING: outswing     Insulpour 350T Thermal 2 1/4" doors   DOOR FINISH: TBD     601UT storefronts   ARCH. HW. SET:     601UT Storefronts	DOOR OPENING:   3'-0"x 7'-10 "   SF #W35 PROJECT TERRACE   LEAVES: SINGLE   SWING:   DOOR FINISH:   TBD   DOOR TINISH:   TBD   TBD   DOOR TINISH:   TBD   DOOR TINISH:   TBD   DOOR TINISH:   TBD   DOOR TINISH:   TBD   DOOR TINISH:   TBD   DOOR TINISH:   TBD   DOOR TINISH:   TBD   DOOR TINISH:   TBD   DOOR TINISH:   TBD   DOOR TINISH:   TBD   DOOR TINISH:   TBD   DOOR TINISH:   TBD   DOOR TINISH:   TBD   DOOR TINISH:   TBD   DOOR TINISH:   TBD   DOOR TINISH:   TBD   DOOR TINISH:   TBD   DOOR TINISH:   TBD   TBD   DOOR TINISH:   TBD   TBD   DOOR TINISH:   TBD   DOOR TINI	2535   DOOR OPENING:   3'-0"x 7'-10 "   SF #W35 PROJECT TERRACE   LEAVES:   SINGLE   outswing   o

- 1. COORDINATION OF ACCESS CONTROL, ELECTRIC HARDWARE AND SECURITY SYSTEM BY OTHERS.
- \* FROM BOTTOM OF DOOR TO CENTERLINE OF TOP ATTACHMENT
- \*\* FROM BOTTOM OF DOOR TO CENTERLINE OF PUSH BAR
- \*\*\* FROM BOTTOM OF DOOR TO CENTERLINE CYLINDER

DOOR #:	2710A		QUANTITY:	1		<u> </u>	T
ARCHITECT'S DOOR #:	2710		DOOR OPENING:	3'-0"x 8'-0 1/4"			
LOCATION:	SF #E05 I	PRE KINDERGARDEN	LEAVES:	SINGLE	_		
MANUFACTURER:	Kawneer		SWING:	outswing	upply	۵	stall
DOOR TYPE:	Insulpour 3	350T Thermal 2 1/4" doors	DOOR FINISH:	TBD	d n	rep	st
FRAMING SYSTEM HEAD:			ARCH. HW. SET:	4	S.	۵.	-
FRAMING SYSTEM JAMB:	601UT Sto	refronts			¥	¥	Y
HARDWARE	QTY/LEAF	MANUFACTURER/DESCRIPTION	FINISH	NOTES/DIMENSIONS			
CONT HINGES	1	Ives 112HD-EPT	630				
OVERHEAD STOP	1	GLY 100S	630	Concealed heavy duty			
STOREROOM LOCK	1	SCHLAGE L9080	US26D	1/2" INS Kit			
CLOSER	1	LCN 4040XP REG OR PA (AS REQUIRED)	689	V		******	
CLOSER DROP PLATES	1	LCN 4040XP-18G	689				
KICK PLATE	1	IVES 8400 10" X 2" LDW B-CS					
DRIP CAP	1	Zero 142	626				
GASKETING	set	ZERO 429					
THRESHOLD	1	ZERO 8655G (verify jamb depth)		By kawneer			
DOOR SWEEPS	1	Zero 8198AA	626				
DOOR CONTACTS	1	Sce 679-05HM/WD		BY OTHERS			

- 1. COORDINATION OF ACCESS CONTROL, ELECTRIC HARDWARE AND SECURITY SYSTEM BY OTHERS.
- \* FROM BOTTOM OF DOOR TO CENTERLINE OF TOP ATTACHMENT
- \*\* FROM BOTTOM OF DOOR TO CENTERLINE OF PUSH BAR
- \*\*\* FROM BOTTOM OF DOOR TO CENTERLINE CYLINDER

DOOR #	: 2718A		QUANTITY:	1	Γ		T
ARCHITECT'S DOOR #	2718		DOOR OPENING:	3'-0"x 8'-0 1/4"	İ		
LOCATION	SF #E06	PRE KINDERGARDEN	LEAVES:	SINGLE	۱、		
MANUFACTURER	Kawneer		SWING:	outswing	upply	۵	Install
DOOR TYPE	Insulpour	350T Thermal 2 1/4" doors	DOOR FINISH:	TBD	ဌ	rep	13
FRAMING SYSTEM HEAD	601UT st	orefronts	ARCH. HW. SET: 4	4	S	<u> </u>	≒
FRAMING SYSTEM JAMB	601UT S	orefronts			K	¥	Y
HARDWARE	QTY/LEA	MANUFACTURER/DESCRIPTION	FINISH	NOTES/DIMENSIONS			
CONT HINGES	1	Ives 112HD-EPT	630				
OVERHEAD STOP	1	GLY 100S	630	Concealed heavy duty			
STOREROOM LOCK	1	SCHLAGE L9080	US26D	1/2" INS Kit			
CLOSER	1	LCN 4040XP REG OR PA (AS REQUIRED)	689				
CLOSER DROP PLATES	1	LCN 4040XP-18G	689	999-Wall			
KICK PLATE	1	IVES 8400 10" X 2" LDW B-CS					
DRIP CAP	1	Zero 142	626				
GASKETING	set	ZERO 429		7704			
THRESHOLD	1	ZERO 8655G (verify jamb depth)		By kawneer			
DOOR SWEEPS	1	Zero 8198AA	626				
DOOR CONTACTS	1	Sce 679-05HM/WD		BY OTHERS			

- 1. COORDINATION OF ACCESS CONTROL, ELECTRIC HARDWARE AND SECURITY SYSTEM BY OTHERS.
- \* FROM BOTTOM OF DOOR TO CENTERLINE OF TOP ATTACHMENT
- \*\* FROM BOTTOM OF DOOR TO CENTERLINE OF PUSH BAR
- \*\*\* FROM BOTTOM OF DOOR TO CENTERLINE CYLINDER

DOOR#	: 2720A		QUANTITY:	1			Т
ARCHITECT'S DOOR #	2720	The state of the s	DOOR OPENING:	3'-0"x 8'-0 1/4"			
LOCATION	SF #E09	PRE KINDERGARDEN	LEAVES:	SINGLE		İ	
MANUFACTURER	Kawneer		SWING:	outswing	Supply		一層
DOOR TYPE	Insulpour	350T Thermal 2 1/4" doors	DOOR FINISH:	TBD	읔	Je p	Install
FRAMING SYSTEM HEAD	601UT st	orefronts	ARCH. HW. SET:	4	S	٠	트
FRAMING SYSTEM JAMB	601UT S	torefronts			×	7	<del>'</del>
HARDWARE	QTY/LEA	MANUFACTURER/DESCRIPTION	FINISH	NOTES/DIMENSIONS			Ī
CONT HINGES	1	Ives 112HD-EPT	630				
OVERHEAD STOP	1	GLY 100S	630	Concealed heavy duty			t
STOREROOM LOCK	1	SCHLAGE L9080	US26D	1/2" INS Kit			
CLOSER	1	LCN 4040XP REG OR PA (AS REQUIRED)	689				<b></b>
CLOSER DROP PLATES	1	LCN 4040XP-18G	689				
KICK PLATE	1	IVES 8400 10" X 2" LDW B-CS					İ
DRIP CAP	1	Zero 142	626				
GASKETING	set	ZERO 429		· · · · · · · · · · · · · · · · · · ·			
THRESHOLD	1	ZERO 8655G (verify jamb depth)		By kawneer			
DOOR SWEEPS	1	Zero 8198AA	626			i	
DOOR CONTACTS	1	Sce 679-05HM/WD		BY OTHERS			

- 1. COORDINATION OF ACCESS CONTROL, ELECTRIC HARDWARE AND SECURITY SYSTEM BY OTHERS.
- \* FROM BOTTOM OF DOOR TO CENTERLINE OF TOP ATTACHMENT
- \*\* FROM BOTTOM OF DOOR TO CENTERLINE OF PUSH BAR
- \*\*\* FROM BOTTOM OF DOOR TO CENTERLINE CYLINDER

DOOR #:	2910A		QUANTITY:	1	Π		Т
ARCHITECT'S DOOR #	2910		DOOR OPENING:	3'-0"x 8'-0 1/4"	ĺ		
LOCATION:	SF #E43	KINDERGARDEN	LEAVES:	SINGLE	۱,		
MANUFACTURER:	Kawneer		SWING:	outswing	upply		Install
DOOR TYPE:	Insulpour	350T Thermal 2 1/4" doors	DOOR FINISH:	TBD	물	rep	ıst
FRAMING SYSTEM HEAD:		TOTAL PROPERTY AND A STATE OF THE STATE OF T	ARCH. HW. SET:	4	S-	٠.	-
FRAMING SYSTEM JAMB:	601UT St	orefronts			Ж	Y	×
HARDWARE	QTY/LEAI	MANUFACTURER/DESCRIPTION	FINISH	NOTES/DIMENSIONS			
CONT HINGES	1	Ives 112HD-EPT	630				
OVERHEAD STOP	1	GLY 100S	630	Concealed heavy duty			
STOREROOM LOCK	1	SCHLAGE L9080	US26D	1/2" INS Kit			
CLOSER	1	LCN 4040XP REG OR PA (AS REQUIRED)	689				
CLOSER DROP PLATES	1	LCN 4040XP-18G	689				
KICK PLATE	1	IVES 8400 10" X 2" LDW B-CS					
DRIP CAP	1	Zero 142	626				
GASKETING	set	ZERO 429					
THRESHOLD	1	ZERO 8655G (verify jamb depth)		By kawneer			
DOOR SWEEPS	1	Zero 8198AA	626	7787794(1)			
DOOR CONTACTS	1	Sce 679-05HM/WD		BY OTHERS			

- 1. COORDINATION OF ACCESS CONTROL, ELECTRIC HARDWARE AND SECURITY SYSTEM BY OTHERS.
- \* FROM BOTTOM OF DOOR TO CENTERLINE OF TOP ATTACHMENT
- \*\* FROM BOTTOM OF DOOR TO CENTERLINE OF PUSH BAR
- \*\*\* FROM BOTTOM OF DOOR TO CENTERLINE CYLINDER

DOOR #:	2918A		QUANTITY:	1	Ī		Τ
ARCHITECT'S DOOR #:	2918		DOOR OPENING:	3'-0"x 7'-11"			
LOCATION:	SF #E11	KINDERGARDEN	LEAVES:	SINGLE			1
MANUFACTURER:	Kawneer		SWING:	outswing	upply		nstall
DOOR TYPE:	Insulpour	350T Thermal 2 1/4" doors	DOOR FINISH:	TBD	<b> </b>	e d	st
FRAMING SYSTEM HEAD:	601UT st	orefronts	ARCH. HW. SET:	4	Š	4	<del>-</del>
FRAMING SYSTEM JAMB:	601UT St	orefronts		· · · · · · · · · · · · · · · · · · ·	¥	¥	¥
HARDWARE	QTY/LEA	MANUFACTURER/DESCRIPTION	FINISH	NOTES/DIMENSIONS			T
CONT HINGES	1	Ives 112HD-EPT	630				
OVERHEAD STOP	1	GLY 100S	630	Concealed heavy duty			
STOREROOM LOCK	1	SCHLAGE L9080	US26D	1/2" INS Kit			
CLOSER	1	LCN 4040XP REG OR PA (AS REQUIRED)	689				
CLOSER DROP PLATES	1	LCN 4040XP-18G	689				
KICK PLATE	1	IVES 8400 10" X 2" LDW B-CS		~~~			
DRIP CAP	1	Zero 142	626				
GASKETING	set	ZERO 429		S-4			
THRESHOLD	1	ZERO 8655G (verify jamb depth)		By kawneer			
DOOR SWEEPS	1	Zero 8198AA	626	7.0.0.0.0.0.0.0.0.0.0.0.0.0.0.0.0.0.0.0			
DOOR CONTACTS	1	Sce 679-05HM/WD		BY OTHERS			

- 1. COORDINATION OF ACCESS CONTROL, ELECTRIC HARDWARE AND SECURITY SYSTEM BY OTHERS.
- \* FROM BOTTOM OF DOOR TO CENTERLINE OF TOP ATTACHMENT
- \*\* FROM BOTTOM OF DOOR TO CENTERLINE OF PUSH BAR
- \*\*\* FROM BOTTOM OF DOOR TO CENTERLINE CYLINDER

DOOR#	2920A		QUANTITY:	1			T
ARCHITECT'S DOOR #	2920		DOOR OPENING:	3'-0"x 8'-0"	1		
LOCATION	SF #E12	KINDERGARDEN	LEAVES:	SINGLE	_		
MANUFACTURER	Kawneer		SWING:	outswing	upply		nstall
DOOR TYPE	Insulpour	350T Thermal 2 1/4" doors	DOOR FINISH:	TBD	g	Prep	ıst
FRAMING SYSTEM HEAD	601UT st	orefronts	ARCH. HW. SET:	4	Š	٠.	=
FRAMING SYSTEM JAMB	601UT St	orefronts			Ж	¥	¥
HARDWARE	QTY/LEAF	MANUFACTURER/DESCRIPTION	FINISH	NOTES/DIMENSIONS			
CONT HINGES	1	Ives 112HD-EPT	630				
OVERHEAD STOP	1	GLY 100S	630	Concealed heavy duty			
STOREROOM LOCK	1	SCHLAGE L9080	US26D	1/2" INS Kit			
CLOSER	1	LCN 4040XP REG OR PA (AS REQUIRED)	689			1	
CLOSER DROP PLATES	1	LCN 4040XP-18G	689				
KICK PLATE	1	IVES 8400 10" X 2" LDW B-CS					
DRIP CAP	1	Zero 142	626				
GASKETING	set	ZERO 429					
THRESHOLD	1	ZERO 8655G (verify jamb depth)		By kawneer			
DOOR SWEEPS	1	Zero 8198AA	626				
DOOR CONTACTS	1	Sce 679-05HM/WD		BY OTHERS			

- 1. COORDINATION OF ACCESS CONTROL, ELECTRIC HARDWARE AND SECURITY SYSTEM BY OTHERS.
- \* FROM BOTTOM OF DOOR TO CENTERLINE OF TOP ATTACHMENT
- \*\* FROM BOTTOM OF DOOR TO CENTERLINE OF PUSH BAR
- \*\*\* FROM BOTTOM OF DOOR TO CENTERLINE CYLINDER

DOOR #	2928A		QUANTITY:	1			T
ARCHITECT'S DOOR #:	2928		DOOR OPENING:	3'-0"x 8'-0 1/4"			
LOCATION:	SF #E14	KINDERGARDEN	LEAVES:	SINGLE	_	ĺ	
MANUFACTURER:	Kawneer		SWING:	outswing	Supply	۵	stall
DOOR TYPE:	Insulpour	350T Thermal 2 1/4" doors	DOOR FINISH:	TBD	亨	rep	ıst
FRAMING SYSTEM HEAD:	601UT st	orefronts	ARCH. HW. SET:	4	ု	Δ.	=
FRAMING SYSTEM JAMB:	601UT St	orefronts			X	¥	¥
HARDWARE	QTY/LEAF	MANUFACTURER/DESCRIPTION	FINISH	NOTES/DIMENSIONS			П
CONT HINGES	1	Ives 112HD-EPT	630				
OVERHEAD STOP	1	GLY 100S	630	Concealed heavy duty			
STOREROOM LOCK	1	SCHLAGE L9080	US26D	1/2" INS Kit			
CLOSER	1	LCN 4040XP REG OR PA (AS REQUIRED)	689				
CLOSER DROP PLATES	1	LCN 4040XP-18G	689				
KICK PLATE	1	IVES 8400 10" X 2" LDW B-CS					
DRIP CAP	1	Zero 142	626				
GASKETING	set	ZERO 429					
THRESHOLD	1	ZERO 8655G (verify jamb depth)		By kawneer			
DOOR SWEEPS	1	Zero 8198AA	626				
DOOR CONTACTS	1	Sce 679-05HM/WD		BY OTHERS			

- 1. COORDINATION OF ACCESS CONTROL, ELECTRIC HARDWARE AND SECURITY SYSTEM BY OTHERS.
- \* FROM BOTTOM OF DOOR TO CENTERLINE OF TOP ATTACHMENT
- \*\* FROM BOTTOM OF DOOR TO CENTERLINE OF PUSH BAR
- \*\*\* FROM BOTTOM OF DOOR TO CENTERLINE CYLINDER



# **Material Proposal**

Estimator: Anita Justus

Phone: 540-432-7575

Fax:

8530 Michael Driscoll School Doors

Job Number: 1028004E-001

Date Sent: 11/01/2021

E-mail: anita.justus@arconic.com

Sales Rep: Daniel R Triggs Phone: 603-218-9917

E-mail: daniel.triggs@arconic.com

SALEM GLASS CO

3 Technology Way SALEM, MA, 01970 Attention: Danny Blake

Phone: 978.744.5177 Fax: 978.745.4036

Cust #: 3641

Cust Email: dblake@salemglass.com

# This Material Proposal is based on:

Customer email dated 10/20

# This Material Proposal includes:

# DOES NOT INCLUDE RECYCLED CONTENT BILLET

Item Description:		
1. Qualifications	Total design of the second of	

Quoted doors only as no frames are included on request.

Quoted all doors as 500T due to some having to be wide stile due to hardware requirements.

Commercial grade swing doors do not form a watertight enclosure. While somewhat weather resistant these doors have not been tested for water performance. To date, AAMA does not even have a water test for this type of door.

All head/sill/jambs must provide adequate structural support in which to anchor the Kawneer framing using standard anchorage. This proposal does not include any custom anchoring systems. If these are required, an add to the price will be required if they are to be provided by Kawneer.

Hardware not provided by Kawneer has not undergone a hardware compatibility check for the quoted doors. It is the customer's responsibility to review hardware compatibility and request changes based upon the results.

NOTE: This estimate is based on customer supplied material list and takeoff. It is the customer's responsibility to verify that all quoted products meet the need and specifications of the project.

\*\*Silicone Setting Blocks\*\* This quotation is based on using standard EPDM setting blocks and side blocks. If the products in this proposal are being glazed with Viracon glass, please check with a Viracon representative on compatibility with EPDM. Viracon may require the use of silicone setting and side blocks which would result in an added price and an increase in lead times.

#### Finish:

This estimate is based on (1) 2-Coat Sunstorm Finish (non-exotic, non-metallic, non-sun storm, non-white) - any other paint finish may result in an add to the estimate.

#### Stock Length:

All shop drawings, engineering and material take-off are by the customer. Customer will be responsible for providing an itemized stock length list of material at purchase order time.

Job Number: 1028004E-001

#### Freight:

Freight for this quotation is determined for shipment to zip code 01970. If the shipment zip code is different from what is quoted, please contact your Project Manager. If your ship to zip code changes, the freight value is subject to change.

The products in this proposal are based on material shipping in:

1 Shipments of Doors

If additional shipments are required, extra freight charges will apply and your Kawneer Project Manager should be notified.

Estimator's Disclaimer:


This pricing is based on Kawneer's interpretation of the customer's take-off and quantities. Prior to order entry, verification of part numbers, quantities, and finishes listed on the proposal is the responsibility of the customer. Any changes in part numbers, quantities, or finishes will require a change in the quoted amount.

\*\*\*\*\*\*


MATERIALTAKE OFF NOT BY KAWNEER: CUSTOMER SUPPLIED MATERIAL LIST REQUIRED AT TIME OF ORDER ENTRY.

#### NOT INCLUDED


Brakes, Extended Warranties, Fabrication, Fabrication prior to finishing, cutting to size of stock lengths, flashing, Glass & Glazing labor, Material Take-Off, Mock Ups, P.E. Licensed Stamp, Perimeter Anchors, Protective/Strippable Coatings, Shop Drawings, Special or Field Testing, Laboratory Testing, Special Samples, Steel Reinforcing, Concealed Flashing, Structural Calculations, Provisions for LEED

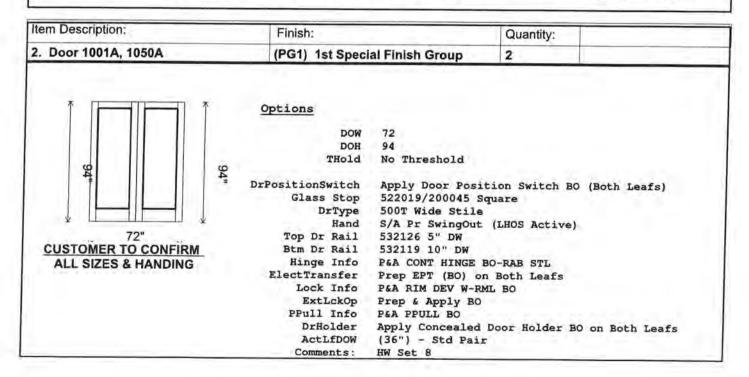


Item Description:	Finish:		Quantity:	
3. Door 1001C, 1050C	(PG1) 1st Speci	al Finish Group	2	
72" CUSTOMER TO CONFIRM ALL SIZES & HANDING	Options  DOW DOH THOID THOID  DrPositionSwitch Glass Stop DrType Hand Top Dr Rail Btm Dr Rail Hinge Info ElectTransfer Lock Info ExtLckOp PPull Info DrHolder ActLfDOW Comments:	500T Wide Stile S/A Pr SwingOut 532126 5" DW 532119 10" DW P&A CONT HINGE E Prep EPT (BO) on P&A RIM DEV W-RM Prep & Apply BO P&A PPULL BO	tion Switch BO quare  (LHOS Active)  BO-RAB STL Both Leafs L BO  Door Holder BO	

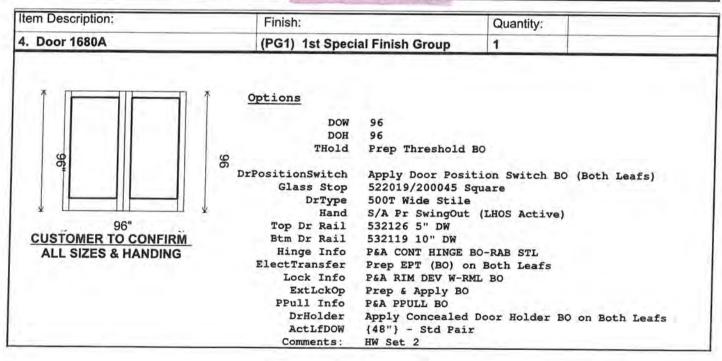

Item Description:	Finish:		Quantity:	
5. Door 1001B, 1050B	(PG1) 1st Speci	al Finish Group	2	
36" CUSTOMER TO CONFIRM ALL SIZES & HANDING	Options  DOW DOH THOID THOID  DrPositionSwitch Glass Stop DrType Hand Top Dr Rail Btm Dr Rail Hinge Info ElectTransfer Lock Info ExtLckOp PPull Info DrHolder Comments:	500T Wide Stile LHOS (H/R Swings 532126 5" DW 532119 10" DW P&A CONT HINGE I Prep EPT (BO) P&A RIM EXIT DEV Prep & Apply BO P&A PPULL BO	tion Switch BO quare Out) BO-RAB STL	

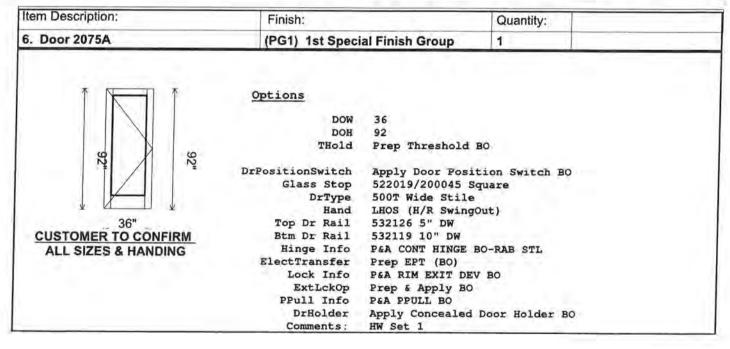


Item Description:	Finish:		Quantity:	
7. Door 1550A, 1550B, 1550C	(PG1) 1st Speci	ial Finish Group	3	
26" CUSTOMER TO CONFIRM ALL SIZES & HANDING	Options  DOW DOH THOID  DrPositionSwitch Glass Stop DrType Hand  Top Dr Rail Btm Dr Rail Hinge Info ElectTransfer Lock Info ExtLckOp PPull Info DrHolder Comments:	500T Wide Stile LHOS (H/R SwingO 532126 5" DW 532119 10" DW	tion Switch BO quare Out) BO-RAB STL	

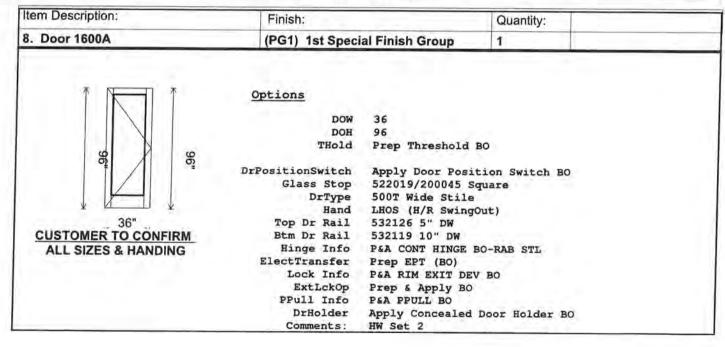


Job Number: 1028004E-001

Item Description:	Finish:		Quantity:	
9. Door 2085A	(PG1) 1st Speci	ial Finish Group	1	
CUSTOMER TO CONFIRM ALL SIZES & HANDING	Options  DOW DOH THOID THOID  DrPositionSwitch Glass Stop DrType Hand Top Dr Rail Btm Dr Rail Hinge Info ElectTransfer Lock Info ExtLckOp PPull Info DrHolder Comments:	500T Wide Stile LHOS (H/R Swings 532126 5" DW 532119 10" DW P&A CONT HINGE F Prep EPT (BO) P&A RIM EXIT DEV Prep & Apply BO P&A PPULL BO	tion Switch BO quare Out) BO-RAB STL	

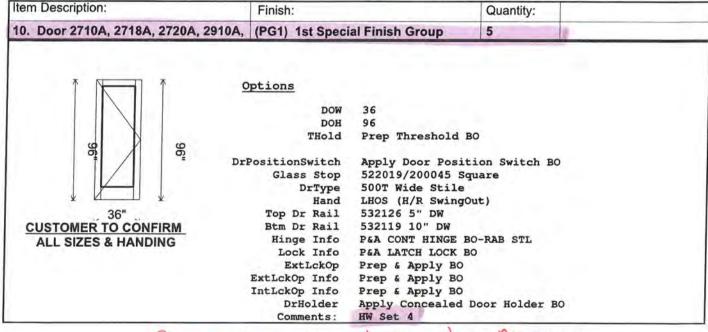


Need TO Be wide Style door Because of Storeroom Luckset lever

Item Description:	Finish:		Quantity:	
11. Door 2918A, 2928A	(PG1) 1st Speci	al Finish Group	2	
294 36" CUSTOMER TO CONFIRM ALL SIZES & HANDING	Options  DOW DOH THOID THOID  DrPositionSwitch Glass Stop DrType Hand Top Dr Rail Btm Dr Rail Hinge Info Lock Info ExtLckOp ExtLckOp Info IntLckOp Info DrHolder	Apply Door Posi 522019/200045 S 500T Wide Stile LHOS (H/R Swing 532126 5" DW 532119 10" DW P&A CONT HINGE 1	tion Switch B quare Out) BO-RAB STL BO	
	Comments:	MIII DEC 1		

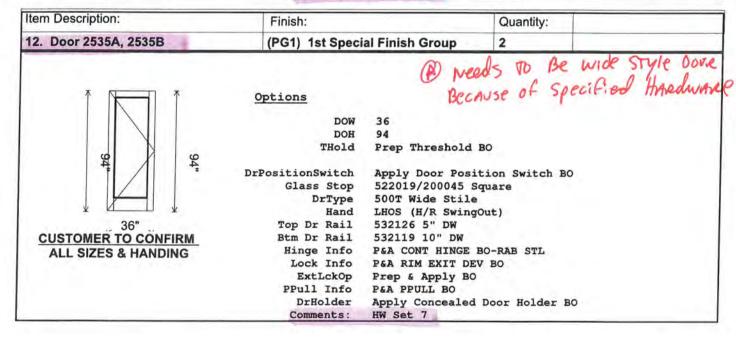

Item Description:	Finish:		Quantity:	
13. Door 1001D, 1050D	(PG1) 1st Spec	al Finish Group	2	
CUSTOMER TO CONFIRM ALL SIZES & HANDING	Options  DOW DOH THOID  DrPositionSwitch Glass Stop DrType Hand Top Dr Rail Btm Dr Rail Hinge Info ElectTransfer Lock Info ExtLckOp PPull Info DrHolder Comments:	500T Wide Stile LHOS (H/R Swinge 532126 5" DW 532119 10" DW P&A CONT HINGE I Prep EPT (BO) P&A RIM EXIT DEV	quare Out) 80-RAB STL 7 BO	

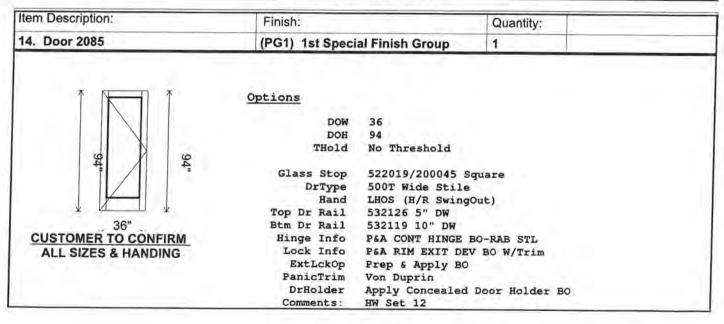

Job Number: 1028004E-001

tem Description:	Finish:		Quantity:	
15. Door 1040A, 1328A, 2070A	(PG1) 1st Special Finish Group		3	
36" CUSTOMER TO CONFIRM ALL SIZES & HANDING	Options  DOW DOH THOID  DrPositionSwitch Glass Stop DrType Hand Top Dr Rail Btm Dr Rail Hinge Info ElectTransfer Lock Info ExtLckOp PPull Info DrHolder Comments:	LHOS (H/R Swing( 532126 5" DW 532119 10" DW P&A CONT HINGE E Prep EPT (BO) P&A RIM EXIT DEV	tion Switch BO quare Out) BO-RAB STL	

Item Description:		
16. Outside Hardware		

#### HW SET 1.000 ARCHSET 1 1 DOOR#: 1050B 1 DOOR#: 1001B CAN STRY @ Medium STyle door if wanted DOOR SIZE: 36" X 94" X 1.75"+0.5" DOOR TYPE: (2) SINGLE MEDIUM STILE THERMAL ALUMINUM DOOR DESC: 350T TOTAL MATERIAL REQUIRED FOR THE ABOVE HARDWARE SET: 2 IVES CONTINUOUS HINGE 93" 628 2 VON DUPRIN POWER TRANSFER SP28 2 VON DUPRIN ELEC RIM EXIT 36" X 1.75"+0.5" 626 2 SCHLAGE FSIC RIM CYLINDER 626 1 SCHLAGE CONTROL KEY 2 BY OTHERS PERMANENT KEYED CORE 48" O.A. X 42" CTC X 1.75"+0.5" 2 ROCKWOOD OFFSET PULL 630 2 GLYNN JOHNSON CONC OH STOP 36" 630 2 LCN SURFACE OPERATOR 689 NOTE: THE 4642 OPERATOR IS INTENDED FOR OCCASIONAL ELECTRIC ACTIVATION. IF THIS IS A HIGH TRAFFIC DOOR, WE RECOMMEND USING THE 9500 SERIES ELECTROMECHANICAL SENIOR SWING. NOTE TO BE FLUSH CEILING MTD. FOR USE IN CONJUNCTION WITH O.H. STOP 2 LCN WALL ACTUATOR 2 LCN DUAL VEST ACTUATOR 2 ZERO DRIP CAP 40" CLR 2 DOOR MFG MFG STD WEATHERING 2 ZERO DOOR SWEEP/DRIP 36" CLR 2 DOOR MFG THRESHOLD 2 SCHLAGE ELEC SE DOOR POSITION SWITCH 2 BY OTHERS BY SECURITY 2 VON DUPRIN POWER SUPPLY 1 SPG ENGINEERIN CUSTOM DIAGRAM 1 SPG ENGINEERIN POINT TO POINT HW SET 1.1 ARCHSET 1 1 DOOR#: 2075A

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DOOR SIZE: 36" X 92" X 1.75"+0.5"
                                                                    style doves it
                                       CAN STAY AS MEdium
  DOOR TYPE: (1) SINGLE MEDIUM STILE
   THERMAL ALUMINUM
  DOOR DESC: 350T
  TOTAL MATERIAL REQUIRED FOR THE ABOVE HARDWARE SET:
  1 IVES CONTINUOUS HINGE 91" 628
  1 VON DUPRIN POWER TRANSFER SP28
  1 VON DUPRIN ELEC RIM EXIT 36" X 1.75"+0.5" 626
  1 SCHLAGE FSIC RIM CYLINDER 626
  1 SCHLAGE CONTROL KEY
  1 BY OTHERS PERMANENT KEYED CORE
  48" O.A. X 42" CTC X 1.75"+0.5"
  1 ROCKWOOD OFFSET PULL 630
  1 GLYNN JOHNSON CONC OH STOP 36" 630
  1 LCN SURFACE OPERATOR 689
  NOTE: THE 4642 OPERATOR IS INTENDED FOR OCCASIONAL ELECTRIC ACTIVATION. IF THIS
  IS A HIGH TRAFFIC DOOR, WE RECOMMEND USING THE 9500 SERIES ELECTROMECHANICAL SENIOR SWING.
  NOTE TO BE FLUSH CEILING MTD. FOR USE IN CONJUNCTION WITH O.H. STOP
  1 LCN WALL ACTUATOR
  1 LCN DUAL VEST ACTUATOR
  1 ZERO DRIP CAP 40" CLR
  1 DOOR MFG MFG STD WEATHERING
 1 ZERO DOOR SWEEP/DRIP 36" CLR
 1 DOOR MFG THRESHOLD
 1 SCHLAGE ELEC SE DOOR POSITION SWITCH
 1 BY OTHERS BY SECURITY
 1 VON DUPRIN POWER SUPPLY
 1 SPG ENGINEERIN CUSTOM DIAGRAM
 1 SPG ENGINEERIN POINT TO POINT
 HW SET 2.000 ARCHSET 2
 1 DOOR#: 1550A
 1 DOOR#: 1550B
                                            STAY & medium STyle dours if Required
 1 DOOR#: 1550C
 DOOR SIZE: 36" X 94" X 1.75"+0.5"
 DOOR TYPE: (3) SINGLE MEDIUM STILE
 THERMAL ALUMINUM
 DOOR DESC: 350T
 TOTAL MATERIAL REQUIRED FOR THE ABOVE HARDWARE SET:
 3 IVES CONTINUOUS HINGE 93" 628
 3 VON DUPRIN POWER TRANSFER SP28
 3 VON DUPRIN RIM EXIT 36" X 1.75"+0.5" 626
3 SCHLAGE FSIC RIM CYLINDER 626
 1 SCHLAGE CONTROL KEY
3 BY OTHERS PERMANENT KEYED CORE
 10" CTC X 1.75"+ 0.5"
3 IVES OFFSET PULL 630
3 GLYNN JOHNSON CONC OH STOP 36" 630
3 LCN SURFACE CLOSER 689
3 LCN DROP PLATE 689
NOTE: CORRECTED DROP PLATE FOR SPECIFIED CLOSER WHICH CANNOT BE TOP JAMB MOUNTED. ADVISE
3 LCN CUSH SUPPORT 689
3 LCN BLADE STOP SPACER 689
3 ZERO DRIP CAP 40" CLR
3 DOOR MFG MFG STD WEATHERING
3 ZERO DOOR SWEEP/DRIP 36" CLR
3 DOOR MFG THRESHOLD
3 SCHLAGE ELEC SE DOOR POSITION SWITCH
HW SET 2.100 ARCHSET 2
1 DOOR#: 1600A
DOOR SIZE: 36" X 96" X 1.75"+0.5"
DOOR TYPE: (1) SINGLE MEDIUM STILE
THERMAL ALUMINUM
DOOR DESC: 350T
TOTAL MATERIAL REQUIRED FOR THE ABOVE HARDWARE SET:
1 IVES CONTINUOUS HINGE 95" 628
1 VON DUPRIN POWER TRANSFER SP28
1 VON DUPRIN RIM EXIT 36" X 1.75"+0.5" 626
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1 SCHLAGE FSIC RIM CYLINDER 626
   1 SCHLAGE CONTROL KEY
   1 BY OTHERS PERMANENT KEYED CORE
   10" CTC X 1.75"+ 0.5"
   1 IVES OFFSET PULL 630
   1 GLYNN JOHNSON CONC OH STOP 36" 630
   1 LCN SURFACE CLOSER 689
   1 LCN DROP PLATE 689
   NOTE: CORRECTED DROP PLATE FOR SPECIFIED CLOSER WHICH CANNOT BE TOP JAMB MOUNTED. ADVISE
   1 LCN CUSH SUPPORT 689
   1 LCN BLADE STOP SPACER 689
  1 ZERO DRIP CAP 40" CLR
  1 DOOR MFG MFG STD WEATHERING
  1 ZERO DOOR SWEEP/DRIP 36" CLR
  1 DOOR MFG THRESHOLD
  1 SCHLAGE ELEC SE DOOR POSITION SWITCH
  HW SET 3.000 ARCHSET 3
                                     CM STAY AS Medium Style doors if Required
  1 DOOR#: 2085A
  DOOR SIZE: 36" X 94" X 1.75"+0.5"
  DOOR TYPE: (1) SINGLE MEDIUM STILE
  THERMAL ALUMINUM
  DOOR DESC: 350T
  TOTAL MATERIAL REQUIRED FOR THE ABOVE HARDWARE SET:
  1 IVES CONTINUOUS HINGE 93" 628
  1 VON DUPRIN POWER TRANSFER SP28
  1 VON DUPRIN ALARMED RIM EXIT 36" X 1,75"+0.5" 626
  1 SCHLAGE FSIC RIM CYLINDER 626
  1 SCHLAGE FSIC MORT CYLINDER 626
 1 SCHLAGE CONTROL KEY
 2 BY OTHERS PERMANENT KEYED CORE
 10" CTC X 1.75"+ 0.5"
 1 IVES OFFSET PULL 630
 1 GLYNN JOHNSON CONC OH STOP 36" 630
 1 LCN SURFACE CLOSER 689
 1 LCN DROP PLATE 689
 NOTE: CORRECTED DROP PLATE FOR SPECIFIED CLOSER WHICH CANNOT BE TOP JAMB MOUNTED. ADVISE
 1 LCN CUSH SUPPORT 689
 1 LCN BLADE STOP SPACER 689
 1 ZERO DRIP CAP 40" CLR
 1 DOOR MFG MFG STD WEATHERING
 1 ZERO DOOR SWEEP/DRIP 36" CLR
 1 DOOR MFG THRESHOLD
 1 SCHLAGE ELEC SE DOOR POSITION SWITCH
 1 BY OTHERS BY SECURITY
 1 VON DUPRIN POWER SUPPLY
 1 SPG ENGINEERIN CUSTOM DIAGRAM
 1 SPG ENGINEERIN POINT TO POINT
 HW SET 4,000 ARCHSET 4
 1 DOOR#: 2710A
 1 DOOR#: 2718A
 1 DOOR#: 2720A
1 DOOR#: 2910A
                                  reeds To Change To wide STyle due To hundware
1 DOOR#: 2902A
DOOR SIZE: 36" X 96" X 1.75"+0.5"
DOOR TYPE: (5) SINGLE WIDE STILE
THERMAL ALUMINUM
DOOR DESC: 500T
NOTE: WIDE STILE REQUIRED
TOTAL MATERIAL REQUIRED FOR THE ABOVE HARDWARE SET:
5 IVES CONTINUOUS HINGE 95" 628
5 SCHLAGE MORT STOREROOM LOCK 1.75"+0.5" 630
NOTE: WIDE STILE REQUIRED
1 SCHLAGE CONTROL KEY
10 BY OTHERS PERMANENT KEYED CORE
5 GLYNN JOHNSON CONC OH STOP 36" 630
5 LCN SURFACE CLOSER 689
5 LCN DROP PLATE 689
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5 IVES KICK PLATE 630 5 ZERO DOOR SWEEP/DRIP 36" CLR 5 DOOR MFG THRESHOLD 5 SCHLAGE ELEC SE DOOR POSITION SWITCH **HW SET 4.1 ARCHSET 4** 1 DOOR#: 2918A weeds to change to wide style down Because of specified handwarp 1 DOOR#: 2928A DOOR SIZE: 36" X 94" X 1.75"+0.5" DOOR TYPE: (2) SINGLE WIDE STILE THERMAL ALUMINUM DOOR DESC: 500T NOTE: WIDE STILE REQUIRED TOTAL MATERIAL REQUIRED FOR THE ABOVE HARDWARE SET: 2 IVES CONTINUOUS HINGE 93" 628 2 SCHLAGE MORT STOREROOM LOCK 1.75"+0.5" 630 NOTE: WIDE STILE REQUIRED 1 SCHLAGE CONTROL KEY 4 BY OTHERS PERMANENT KEYED CORE 2 GLYNN JOHNSON CONC OH STOP 36" 630 2 LCN SURFACE CLOSER 689 2 LCN DROP PLATE 689 2 IVES KICK PLATE 630 2 ZERO DOOR SWEEP/DRIP 36" CLR 2 DOOR MFG THRESHOLD 2 SCHLAGE ELEC SE DOOR POSITION SWITCH HW SET 5.000 ARCHSET 7 1 DOOR#: 1680A Needs To Change To wide STyle doors Because of Specified handware DOOR SIZE: 96" X 96" X 1.75"+0.5" DOOR TYPE: (1) PAIR WIDE STILE THERMAL ALUMINUM DOOR DESC: 500T NOTE: WIDE STILE REQUIRED TOTAL MATERIAL REQUIRED FOR THE ABOVE HARDWARE SET: 2 IVES CONTINUOUS HINGE 95" 628 1 VON DUPRIN KEY REM MULLION 7'-6" SP28 NOTE: MULLION / EXIT COMBINATION REQUIRES WIDE STILE 1 VON DUPRIN RIM EXIT 48" X 1.75"+0.5" 626 1 VON DUPRIN RIM EXIT 48" X 1.75"+0.5" 628 1 SCHLAGE FSIC RIM CYLINDER 626 1 SCHLAGE FSIC MORT CYLINDER 626 FOR MULLION 2 SCHLAGE FSIC MORTISE CYLINDER 626 FOR CYLINDER DOGGING 1 SCHLAGE CONTROL KEY 3 BY OTHERS PERMANENT KEYED CORE 48" O.A. X 42" CTC X 1.75"+0.5" 2 ROCKWOOD OFFSET PULL 630 2 GLYNN JOHNSON CONC OH STOP 48" 630 2 LCN SURFACE CLOSER 689 2 LCN DROP PLATE 689 NOTE: CORRECTED DROP PLATE FOR SPECIFIED CLOSER WHICH CANNOT BE TOP JAMB MOUNTED. ADVISE 2 LCN BLADE STOP SPACER 689 1 ZERO DRIP CAP 100" CLR 1 DOOR MFG MFG STD WEATHERING 2 ZERO DOOR SWEEP/DRIP 48" CLR 1 DOOR MFG THRESHOLD 2 SCHLAGE ELEC SE DOOR POSITION SWITCH HW SET 5.100 ARCHSET 7 MOD. 1 DOOR#: 2535A CAN STRY AS Medium Style doors if Required 1 DOOR#: 2535B DOOR SIZE: 36" X 94" X 1.75"+0.5" DOOR TYPE: (2) SINGLE MEDIUM STILE THERMAL ALUMINUM DOOR DESC: 350T

THIS HOW SET HAS BEEN MODIFIED FOR A SINGLE DOOR LEAF.

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TOTAL MATERIAL REQUIRED FOR THE ABOVE HARDWARE SET:
  2 IVES CONTINUOUS HINGE 93" 628
  2 VON DUPRIN RIM EXIT 36" X 1.75"+0.5" 628
  2 SCHLAGE FSIC RIM CYLINDER 626
  2 SCHLAGE FSIC MORTISE CYLINDER 626
  1 SCHLAGE CONTROL KEY
  2 BY OTHERS PERMANENT KEYED CORE
 48" O.A. X 42" CTC
 X 1.75"+0.5"
 2 ROCKWOOD OFFSET PULL 630
 2 GLYNN JOHNSON CONC OH STOP 36" 630
 2 LCN SURFACE CLOSER 689
 2 LCN DROP PLATE 689
 NOTE: CORRECTED DROP PLATE FOR SPECIFIED CLOSER WHICH CANNOT BE TOP JAMB MOUNTED, ADVISE
 2 LCN BLADE STOP SPACER 689
 2 ZERO DRIP CAP 40" CLR
 2 DOOR MFG MFG STD WEATHERING
 2 ZERO DOOR SWEEP/DRIP 36" CLR
 2 DOOR MFG THRESHOLD
 2 SCHLAGE ELEC SE DOOR POSITION SWITCH
 HW SET 6.000 ARCHSET 8
 1 DOOR#: 1001A
                                            STAY as medium style doves if Required
 1 DOOR#: 1050A
 DOOR SIZE: 72" X 94" X 1.75"+0.5"
 DOOR TYPE: (2) PAIR MEDIUM STILE
 THERMAL ALUMINUM
 DOOR DESC: 350T
 TOTAL MATERIAL REQUIRED FOR THE ABOVE HARDWARE SET:
 4 IVES CONTINUOUS HINGE 93" 628
 4 VON DUPRIN POWER TRANSFER SP28
 2 VON DUPRIN KEY REM MULLION 8'-6" SP28
 2 VON DUPRIN ELEC RIM EXIT 36" X 1.75"+0.5" 626
 2 VON DUPRIN ELEC RIM EXIT 36" X 1.75"+0.5" 626
 2 SCHLAGE FSIC RIM CYLINDER 626
 2 SCHLAGE FSIC MORT CYLINDER 626
 1 SCHLAGE CONTROL KEY
 4 BY OTHERS PERMANENT KEYED CORE
48" O.A. X 42" CTC X 1.75"+0.5"
4 ROCKWOOD OFFSET PULL 630
4 GLYNN JOHNSON CONC OH STOP 36" 630
4 LCN SURFACE CLOSER 689
4 LCN DROP PLATE 689
NOTE: CORRECTED DROP PLATE FOR SPECIFIED CLOSER WHICH CANNOT BE TOP JAMB MOUNTED. ADVISE
4 LCN BLADE STOP SPACER 689
2 ZERO DRIP CAP 76" CLR
2 DOOR MFG MFG STD WEATHERING
4 ZERO DOOR SWEEP/DRIP 36" CLR
2 DOOR MFG THRESHOLD
4 SCHLAGE ELEC SE DOOR POSITION SWITCH
2 BY OTHERS BY SECURITY
2 VON DUPRIN POWER SUPPLY
HW SET 7.000 ARCHSET 9
1 DOOR#: 1001D
1 DOOR#: 1050D
                                            STAY as medium style dours if Required
DOOR SIZE: 36" X 94" X 1,75"+0.5"
DOOR TYPE: (2) SINGLE MEDIUM STILE
THERMAL ALUMINUM
DOOR DESC: 350T
TOTAL MATERIAL REQUIRED FOR THE ABOVE HARDWARE SET:
2 IVES CONTINUOUS HINGE 93" 628
2 VON DUPRIN POWER TRANSFER SP28
2 VON DUPRIN ELEC RIM EXIT 36" X 1.75"+0.5" 626
2 SCHLAGE FSIC RIM CYLINDER 626
1 SCHLAGE CONTROL KEY
2 BY OTHERS PERMANENT KEYED CORE
48" O.A. X 42" CTC X 1.75"+0.5"
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2 ROCKWOOD OFFSET PULL 630 2 GLYNN JOHNSON CONC OH STOP 36" 630 2 LCN SURFACE OPERATOR 689 NOTE: THE 4642 OPERATOR IS INTENDED FOR OCCASIONAL ELECTRIC ACTIVATION, IF THIS IS A HIGH TRAFFIC DOOR, WE RECOMMEND USING THE 9500 SERIES ELECTROMECHANICAL SENIOR SWING. NOTE TO BE FLUSH CEILING MTD. FOR USE IN CONJUNCTION WITH O.H. STOP 2 LCN WALL ACTUATOR 2 SCHLAGE ELEC SE DOOR POSITION SWITCH 2 BY OTHERS BY SECURITY 2 VON DUPRIN POWER SUPPLY 1 SPG ENGINEERIN CUSTOM DIAGRAM 1 SPG ENGINEERIN POINT TO POINT HW SET 8.000 ARCHSET 11 1 DOOR#: 1001C 1 DOOR#: 1050C weeds to Change To Wide Style down Because of handware DOOR TYPE: (2) PAIR WIDE STILE THERMAL ALUMINUM

DOOR DESC: 500T DOOR DESC: 500T NOTE: WIDE STILE REQUIRED TOTAL MATERIAL REQUIRED FOR THE ABOVE HARDWARE SET: 4 IVES CONTINUOUS HINGE 93" 628 4 VON DUPRIN POWER TRANSFER SP28 2 VON DUPRIN KEY REM MULLION 8'-6" SP28 NOTE: MULLION / EXIT COMBINATION REQUIRES WIDE STILE 2 VON DUPRIN ELEC RIM EXIT 36" X 1.75"+0.5" 626 2 VON DUPRIN ELEC RIM EXIT 36" X 1.75"+0.5" 626 2 SCHLAGE FSIC RIM CYLINDER 626 2 SCHLAGE FSIC MORT CYLINDER 626 1 SCHLAGE CONTROL KEY 4 BY OTHERS PERMANENT KEYED CORE 48" O.A. X 42" CTC X 1.75"+0.5" 4 ROCKWOOD OFFSET PULL 630 4 GLYNN JOHNSON CONC OH STOP 36" 630 4 LCN SURFACE CLOSER 689 4 LCN DROP PLATE 689 NOTE: CORRECTED DROP PLATE FOR SPECIFIED CLOSER WHICH CANNOT BE TOP JAMB MOUNTED. ADVISE 4 LCN BLADE STOP SPACER 689 2 DOOR MFG MFG STD WEATHERING 2 DOOR MFG THRESHOLD 4 SCHLAGE ELEC SE DOOR POSITION SWITCH 2 BY OTHERS BY SECURITY 2 VON DUPRIN POWER SUPPLY HW SET 9.000 ARCHSET 12 CAN STAY AS Medium STyle down if Regulared 1 DOOR#: 2085 DOOR SIZE: 36" X 94" X 1.75"+0.5" DOOR TYPE: (1) SINGLE MEDIUM STILE THERMAL ALUMINUM DOOR DESC: 350T TOTAL MATERIAL REQUIRED FOR THE ABOVE HARDWARE SET: 1 IVES CONTINUOUS HINGE 93" 628 1 VON DUPRIN RIM EXIT W/ LEVER 36" X 1.75"+0.5" 626 1 SCHLAGE FSIC RIM CYLINDER 626 1 SCHLAGE FSIC MORT CYLINDER 626 1 SCHLAGE CONTROL KEY 1 BY OTHERS PERMANENT KEYED CORE 1 GLYNN JOHNSON CONC OH STOP 36" 630 1 LCN SURFACE CLOSER 689 1 LCN DROP PLATE 689 NOTE: CORRECTED DROP PLATE FOR SPECIFIED CLOSER WHICH CANNOT BE TOP JAMB MOUNTED. ADVISE 1 LCN BLADE STOP SPACER 689 1 DOOR MFG MFG STD WEATHERING HW SET 10.000 ARCHSET 16 1 DOOR#: 1040A 1 DOOR#: 1328A

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1 DOOR#: 2070A

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DOOR SIZE: 36" X 94" X 1.75"+0.5"

DOOR TYPE: (3) SINGLE MEDIUM STILE

CAN STAY O

medium style doores 1

s if Regineed

THERMAL ALUMINUM DOOR DESC: 350T

TOTAL MATERIAL REQUIRED FOR THE ABOVE HARDWARE SET:

3 IVES CONTINUOUS HINGE 93" 628
3 VON DUPRIN POWER TRANSFER SP28
3 VON DUPRIN RIM EXIT 36" X 1.75"+0.5" 626
3 GLYNN JOHNSON CONC OH STOP 36" 630

3 LCN SURFACE CLOSER 689 3 LCN DROP PLATE 689

NOTE: CORRECTED DROP PLATE FOR SPECIFIED CLOSER WHICH CANNOT BE TOP JAMB MOUNTED. ADVISE

3 LCN BLADE STOP SPACER 689
3 ZERO DRIP CAP 40" CLR
3 DOOR MFG MFG STD WEATHERING
3 ZERO DOOR SWEEP/DRIP 36" CLR
3 DOOR MFG THRESHOLD

3 SCHLAGE ELEC SE DOOR POSITION SWITCH

Total Base Bid:

\$USD

Freight: Prepaid, FOB Factory

#### **Terms and Conditions**

Note, the prices contained in this estimate are valid for 30 days, and if accepted, are still subject to an inflation add if the materials are not shipped within 6 months from time of estimate.

The products on this Material Proposal are warranted for a period of 2 years